
# SUNOL COMMUNITY SCHOOL BUILDING 'A' RESTROOMS UPGRADE, FIRE ALARM & SITE WORK

SANTA CLARA COUNTY OFFICE OF EDUCATION

394-A Umbarger Rd San Jose, CA 95111

06/27/2017

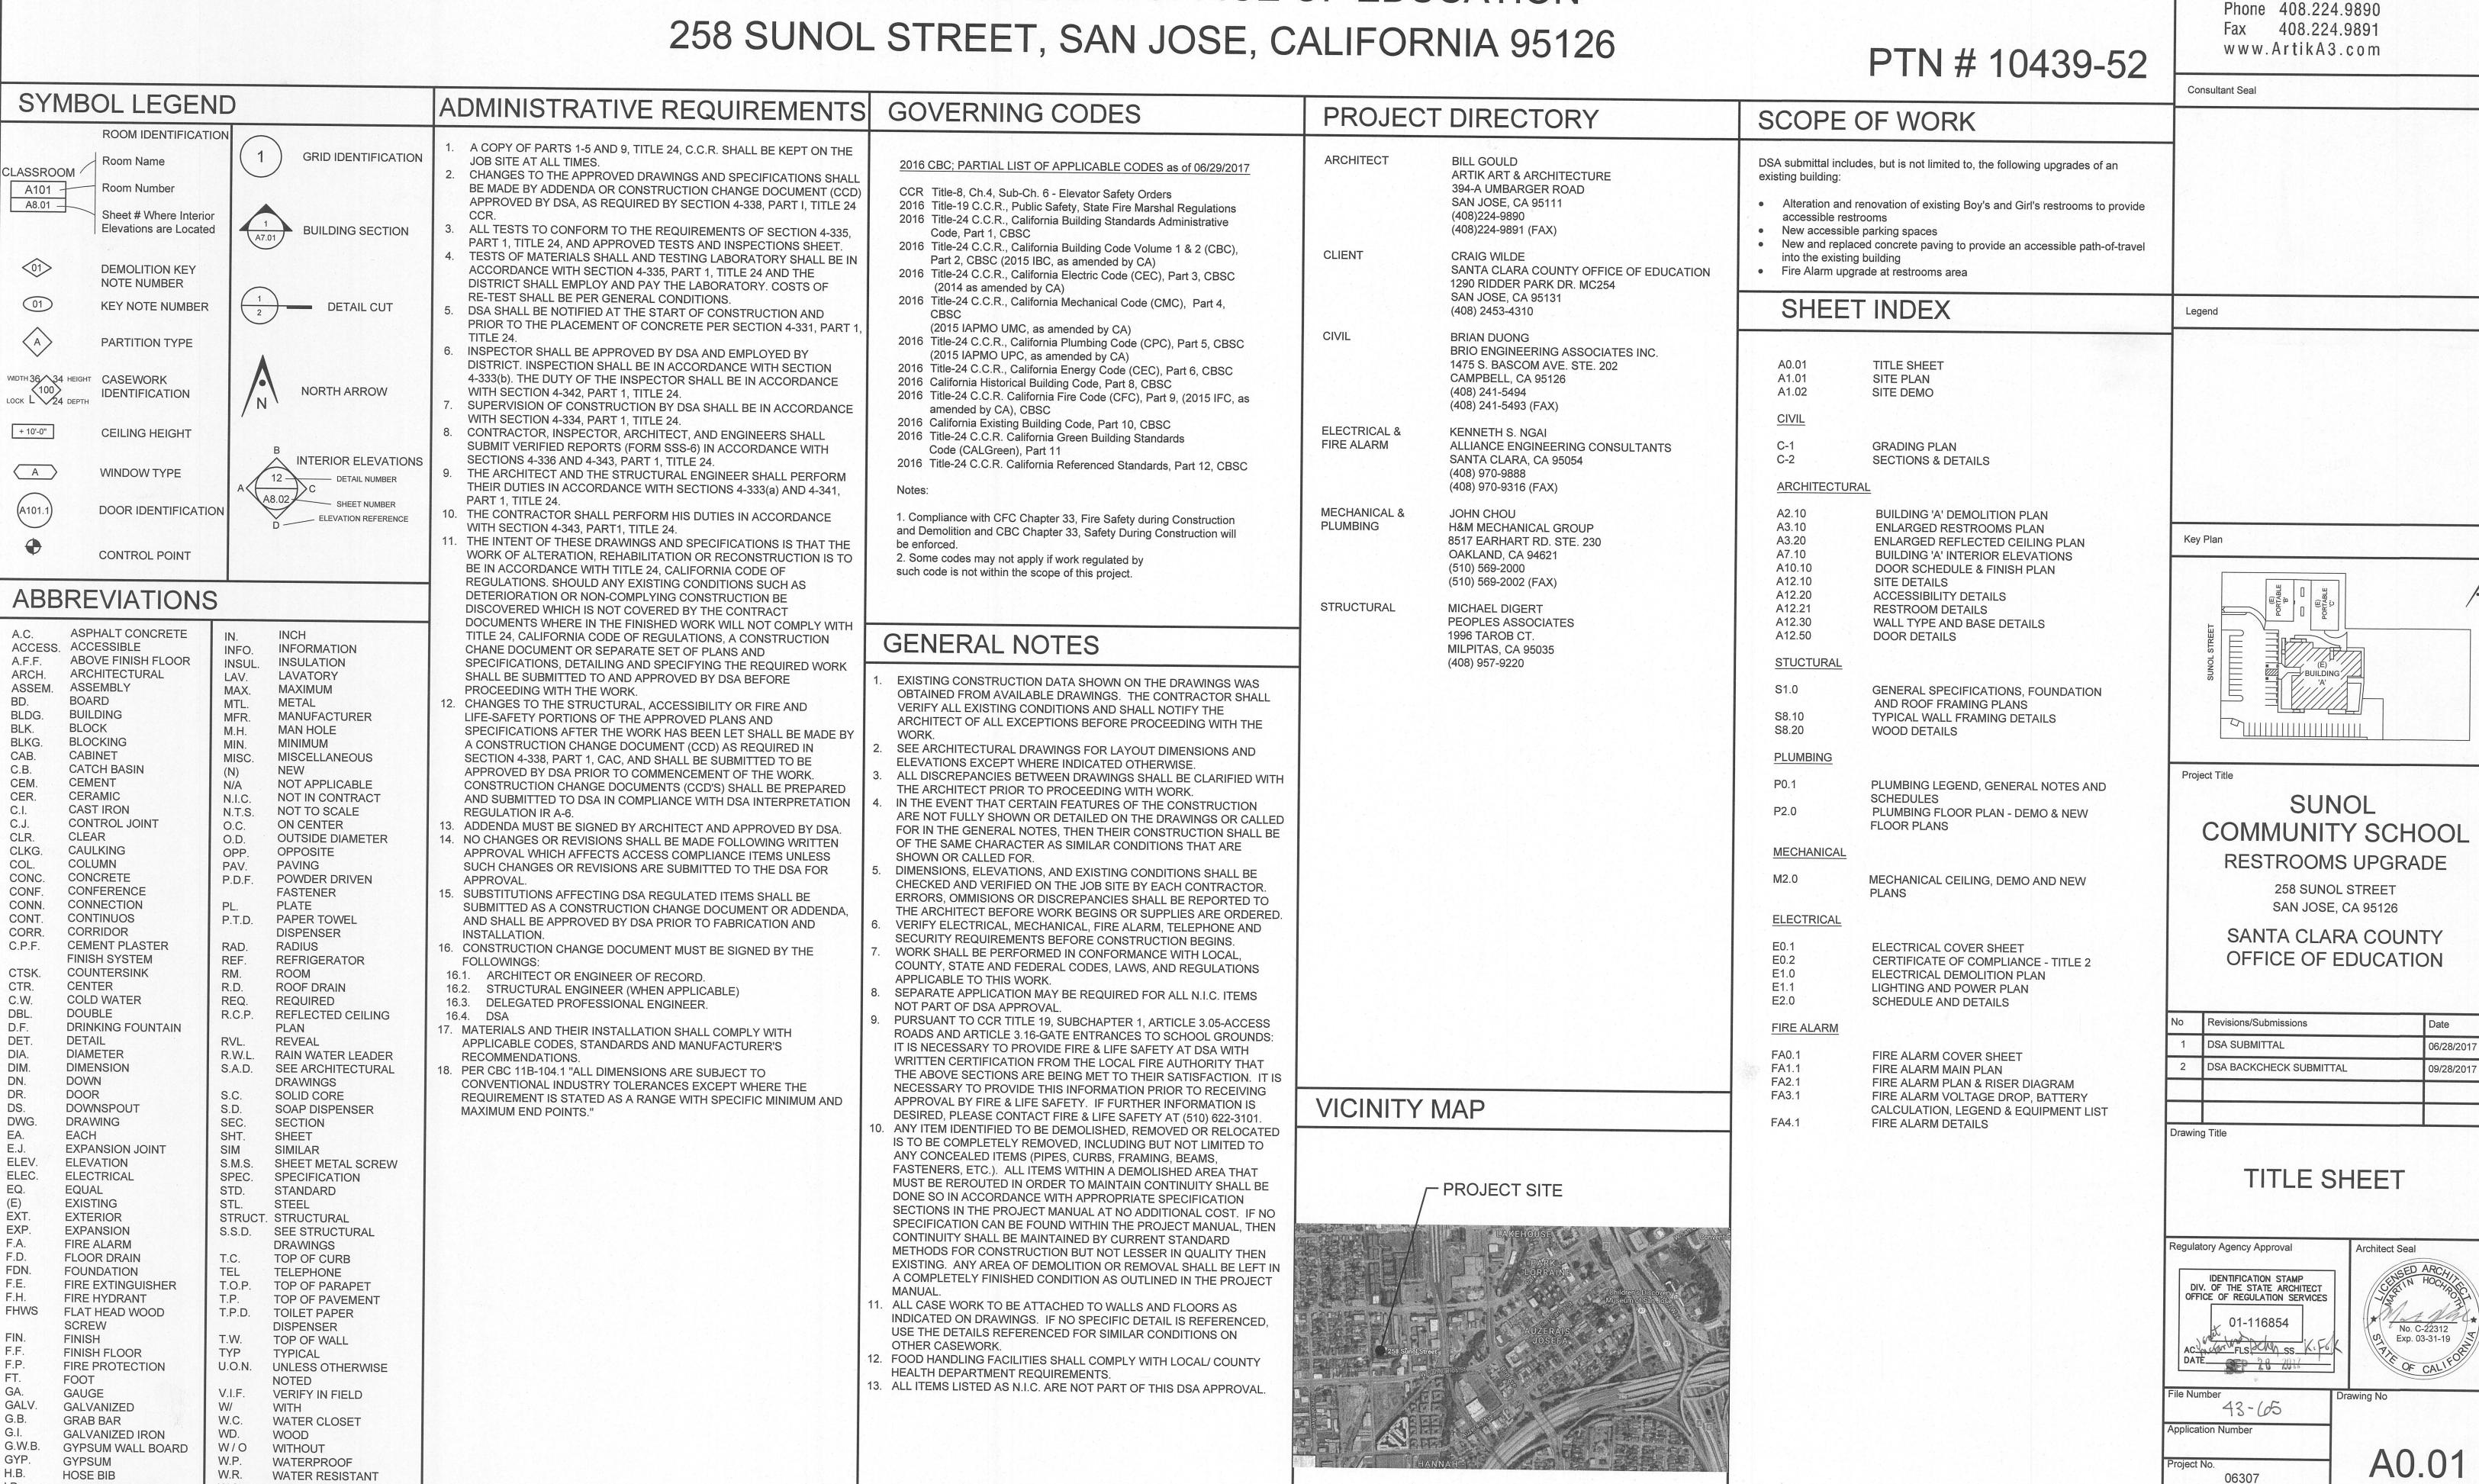


I.D.

INSIDE DIAMETER

W.S.

WEATHER STRIPPING

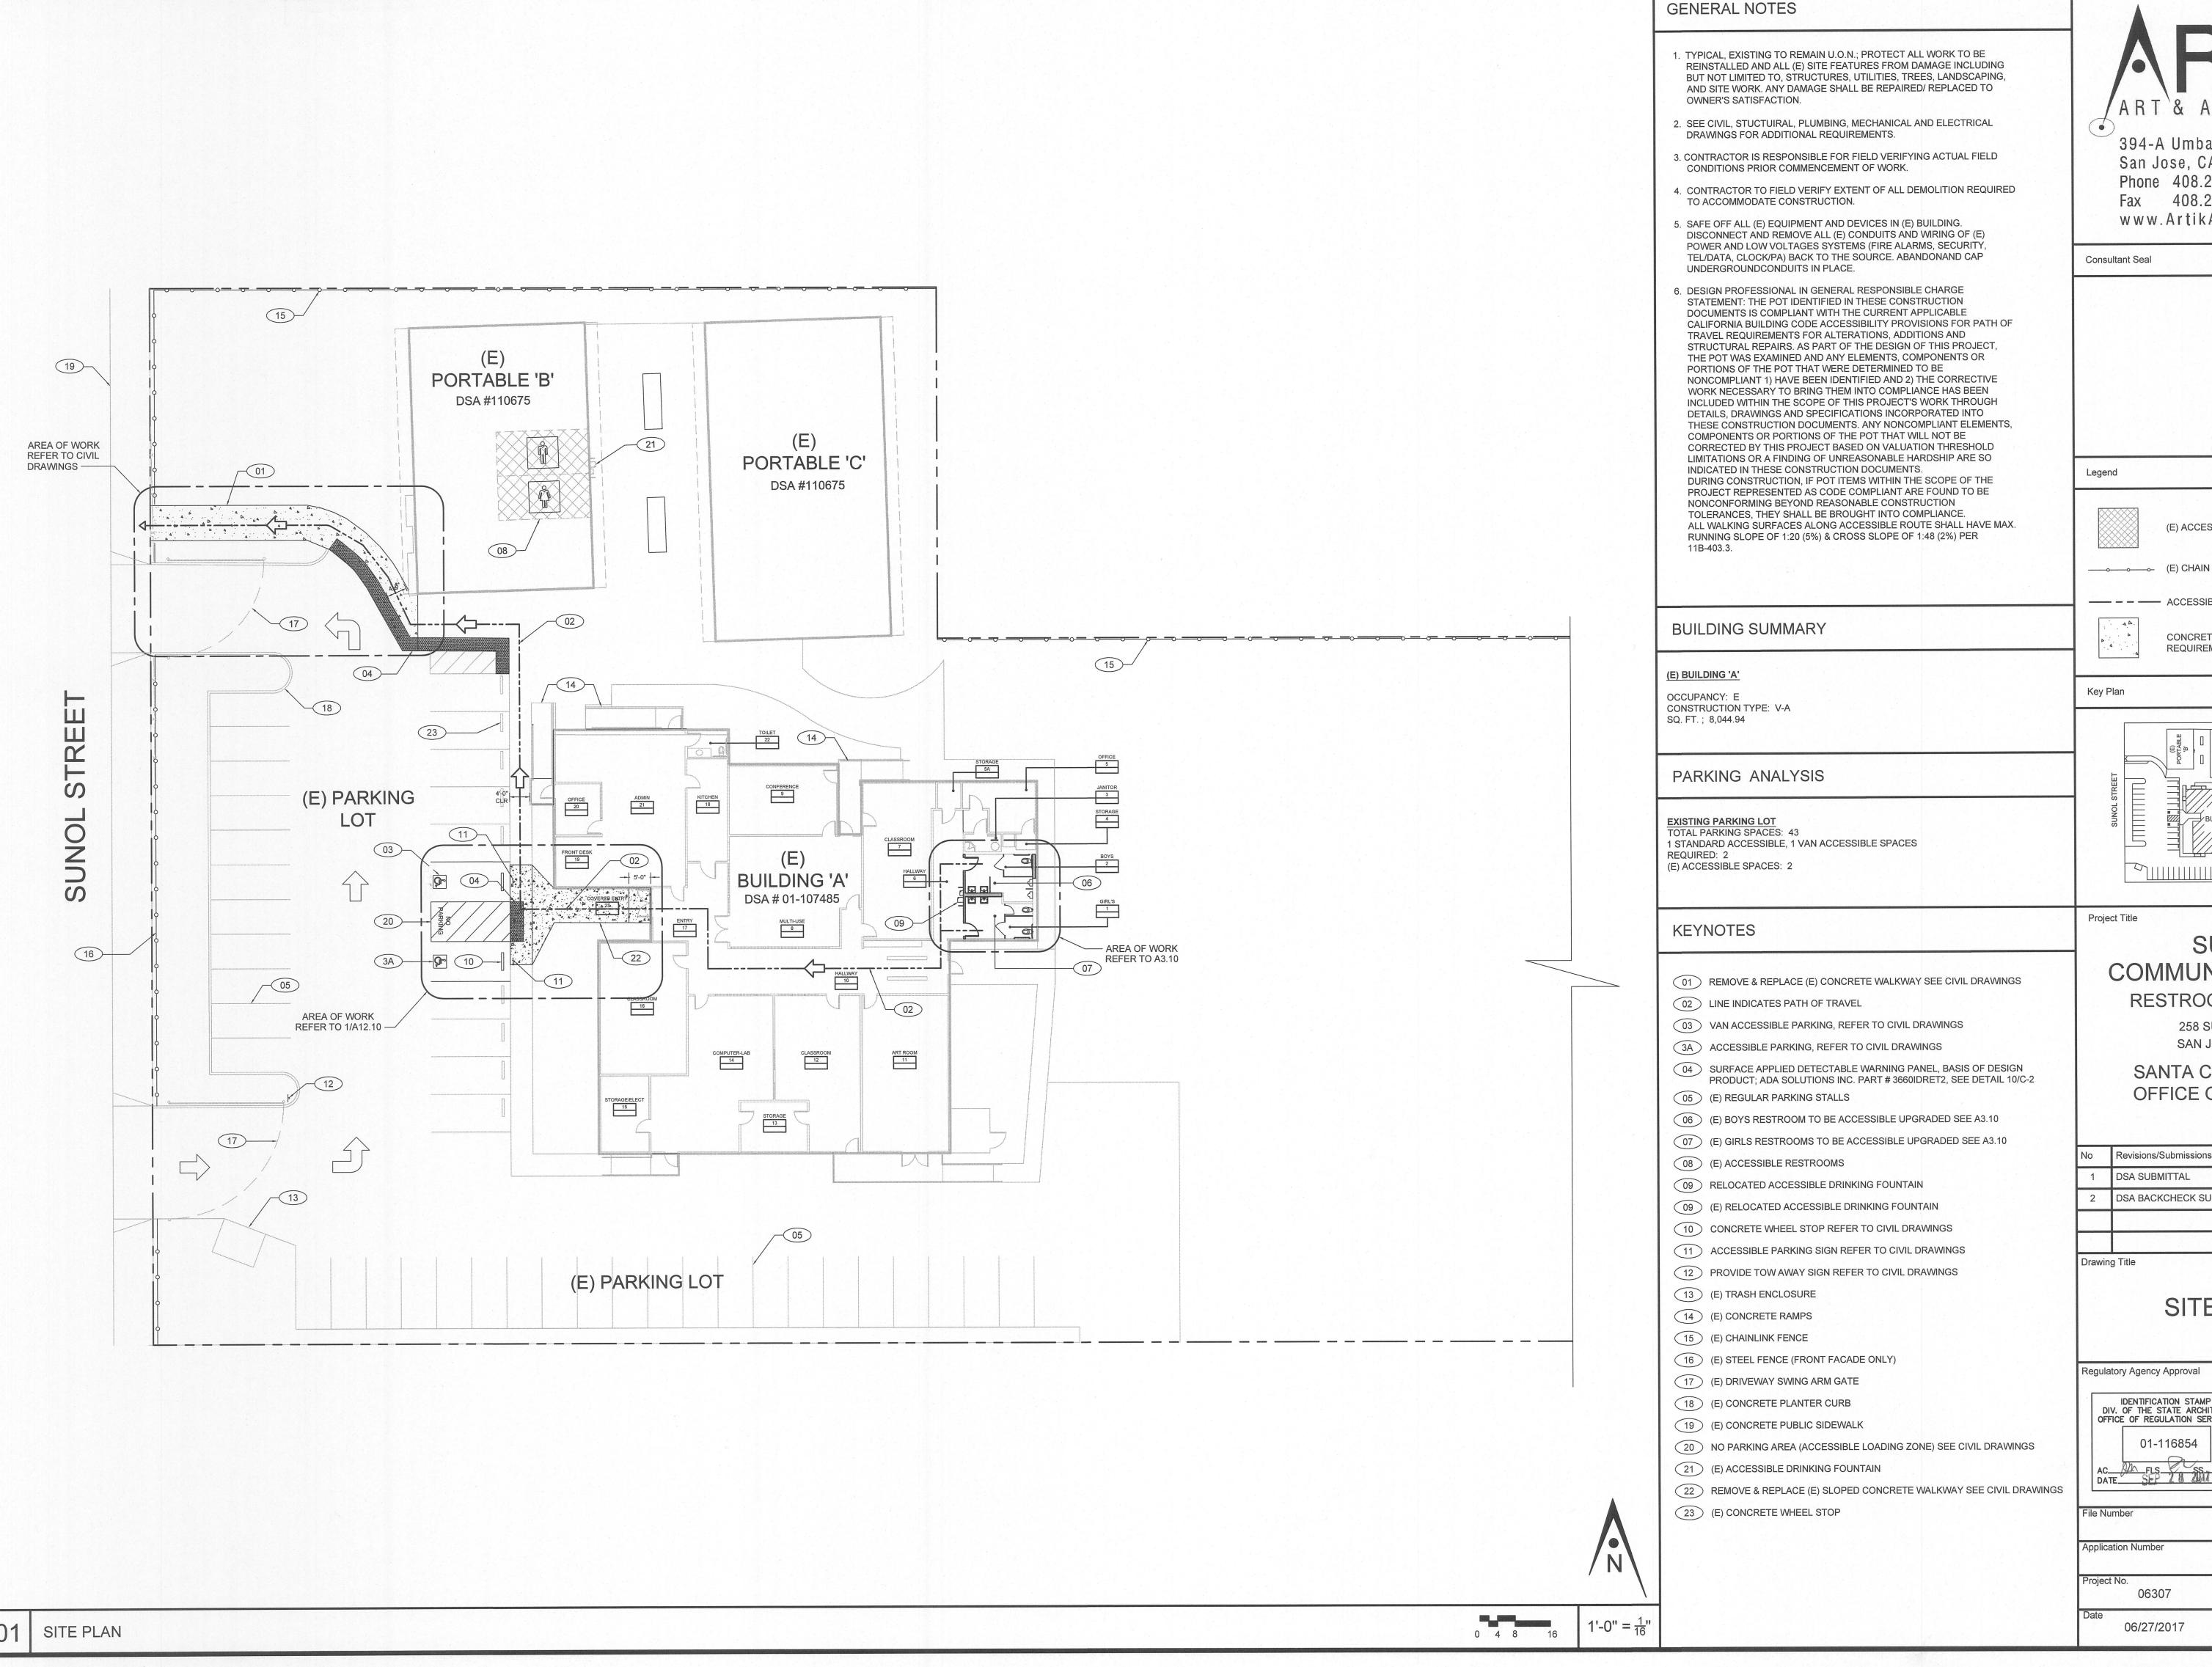

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Consultant Seal




(E) ACCESSIBLE RESTROOMS.

\_\_\_\_\_ (E) CHAIN LINK FENCE TO REMAIN.

---- ACCESSIBLE POT



CONCRETE WALKWAY PROVIDE ADA CODE REQUIREMENTS

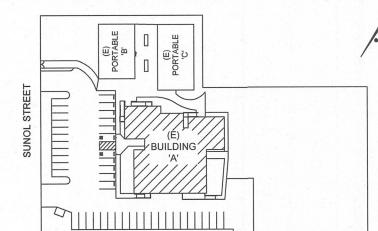

# SUNOL COMMUNITY SCHOOL

RESTROOMS UPGRADE

258 SUNOL STREET SAN JOSE, CA 95126

SANTA CLARA COUNTY OFFICE OF EDUCATION

No	Revisions/Submissions	Date
1	DSA SUBMITTAL	06/28/2017
2	DSA BACKCHECK SUBMITTAL	09/28/2017

SITE PLAN


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OFFICE OF REGULATION SERVICES



Drawing No

Application Number

A1.01

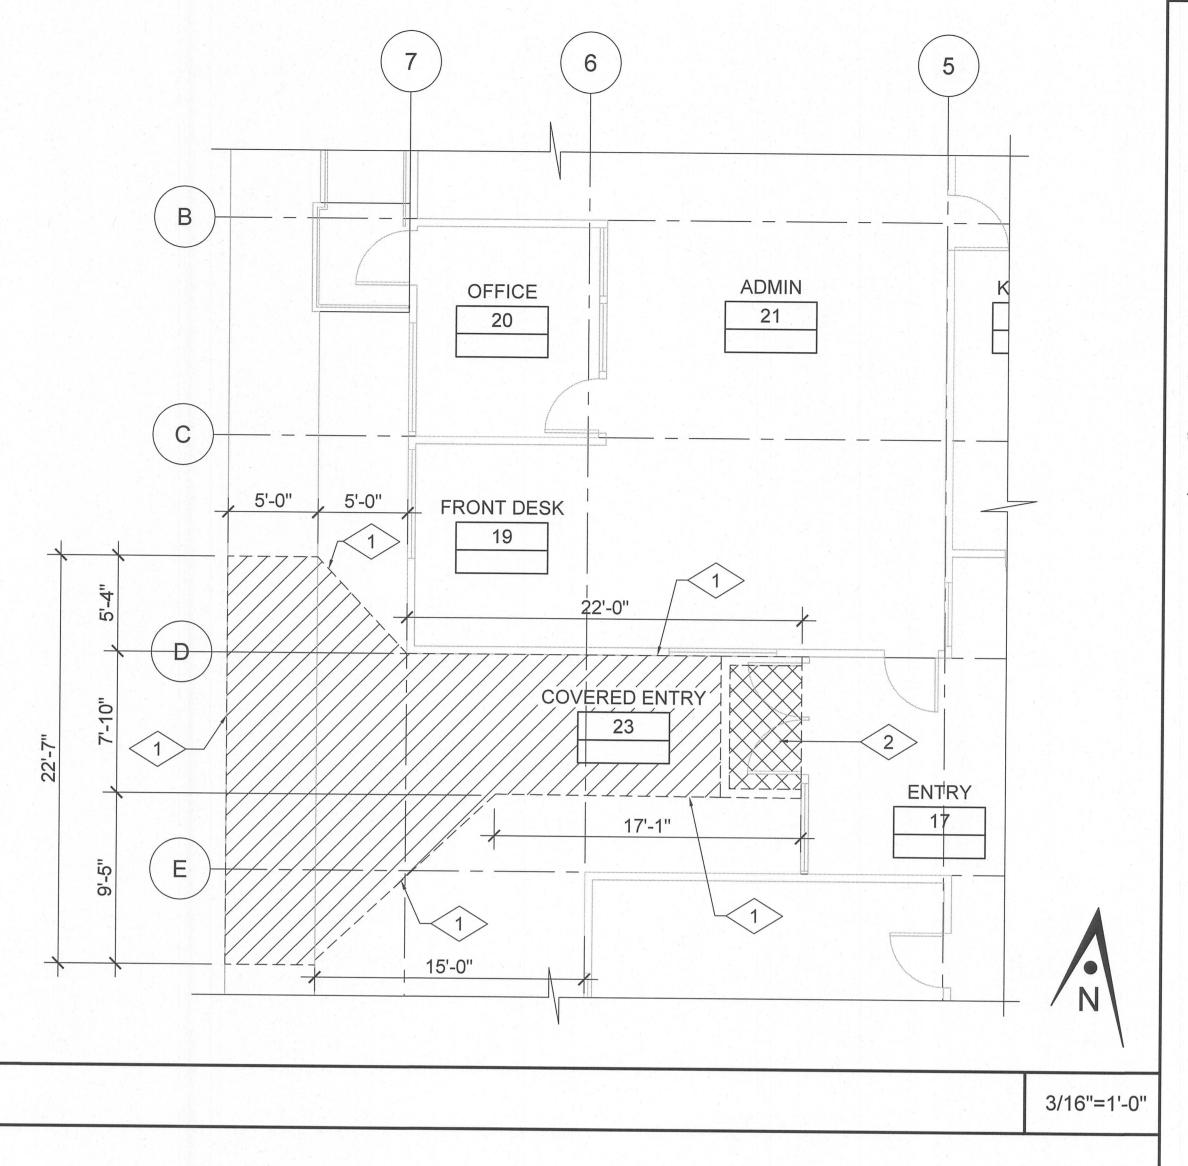

24'-8"

#### **GENERAL NOTES**

- . DEMOLITION PLAN IS DIAGRAMMATIC. CONTRACTOR IS RESPONSIBLE FOR ALL DEMOLITION WORK REQUIRED FOR INSTALLATION OF NEW CONSTRUCTION EVEN IF NOT SPECIFICALLY INDICATED ON THE DEMOLITION DRAWINGS.
- 2. CONTRACTOR SHALL COORDINATE WORK WITH ALL OTHER DISCIPLINES.
- 3. REFER TO PLUMBING, ELECTRICAL, CIVIL AND STRUCTURAL FOR SPECIFIC DEMOLITION SCOPE.
- 4. CONTRACTOR TO COORDINATE ALL SAW CUT IN CONCRETE SLAB AND PAVEMENT AS REQUIRED FOR NEW WORK.
- 5. ALL MATERIAL INDICATED TO BE REMOVED IS TO BE DISPOSED OFF IN A LEGAL MANNER. CONTRACTOR TO CONFIRM WITH OWNER FOR EQUIPMENT TO BE SALVAGED OR STORED
- 6. CONTRACTOR SHALL PROTECT PORTIONS OF EXISTING CONSTRUCTION NOT INDICATED TO BE DEMOLISHED. CONTRACTOR SHALL BE RESPONSIBLE FOR THE REPLACEMENT AND REPAIR OF ITEMS TO REMAIN.
- PARTIAL DEMOLITION TO INCLUDE TRIMMING AND CAPPING SYSTEMS THAT ARE TO REMAIN OPERABLE.
- 8. DISCONNECT (E) PLUMBING FIXTURES TO BE RELOCATED AND/OR REMOVED AND CAP (E) CONNECTIONS. WHERE (E) CONNECTIONS ARE TO BE ABANDONED , CAP SHOULD NOT BE VISIBLE ON OR ABOVE FINISHED SURFACE.
- 9. CONTRACTOR SHALL COORDINATE EXTENT OF DEMOLITION FOR INSTALLATION OF BLOCKING AS NECESSARY FOR ALL DISCIPLINES, AS WELL AS RELOCATION OF ANY EXISTING POWER AND DATA OUTLETS.
- 10. ALL DEMOLITION TO BE DONE PER DISTRICT ABATEMENT REPORT

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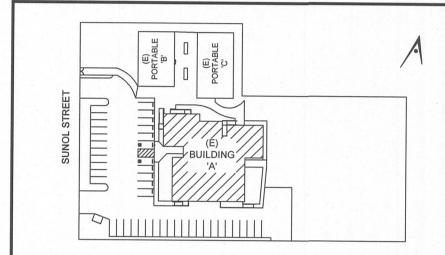
Consultant Seal

Legend

(E) WALLS TO REMAIN DEMO (E) WALL

DEMO (E) DOOR ITEMS TO BE REMOVED

Key Plan



Project Title

# SUNOL COMMUNITY SCHOOL RESTROOMS UPGRADE

258 SUNOL STREET SAN JOSE, CA 95126

SANTA CLARA COUNTY OFFICE OF EDUCATION

No	Revisions/Submissions	Date
1	DSA SUBMITTAL	06/28/2017
2	DSA BACKCHECK SUBMITTAL	09/28/2017

Drawing Title

SITE DEMO

Regulatory Agency Approval IDENTIFICATION STAMP
DIV. OF THE STATE ARCHITECT
OFFICE OF REGULATION SERVICES DATE 2 8 2017

No. C-22312 Exp. 03-31-19

File Number

Application Number

06307

06/27/2017

A1.02

Drawing No

Architect Seal

**DEMO KEYNOTES** 

1 REMOVE & REPLACE (E) FRONT ENTRANE CONCRETE WALKWAY AT BUILDING 'A'

2 DEMO EXISTING DECORATIVE FLOOR MOSAIC

HATCHED AREA INDICATES THE REMOVAL OF THE EXISTING SITE CONCRETE WALKWAY, VERIFY CONDITIONS IN FIELD. REFER TO CIVIL DRAWINGS FOR REPLACEMENT CONCRETE WALKWAY

EXISTING DECORATIVE IRON FENCE TO REMAIN

REMOVE EXISTING DECORATIVE IRON DOUBLE GATE

6 ADJUST 3 EXISTING UTILITY BOXES TO THE NEW GRADE LEVEL VERIFY AND COORDINATE WITH CONTRACTOR, SEE CIVIL DRAWINGS

(E) ELECTRICAL UTILITY BOX TO REMAIN

EXISTING DRIVEWAY SWING ARM GATE TO REMAIN

9 INDICATES PROPERTY LINE

DEMOLITION SITE ENTRY CONCRETE WALKWAY

02 DEMOLITION BUILDING 'A' FRONT ENTRY CONCRETE WALKWAY

4>


<del>9</del>

36'-1"

(E) NORTH ENTRY DRIVEWAY

(E)
PORTABLE
DSA #110675

3/16"=1'-0"

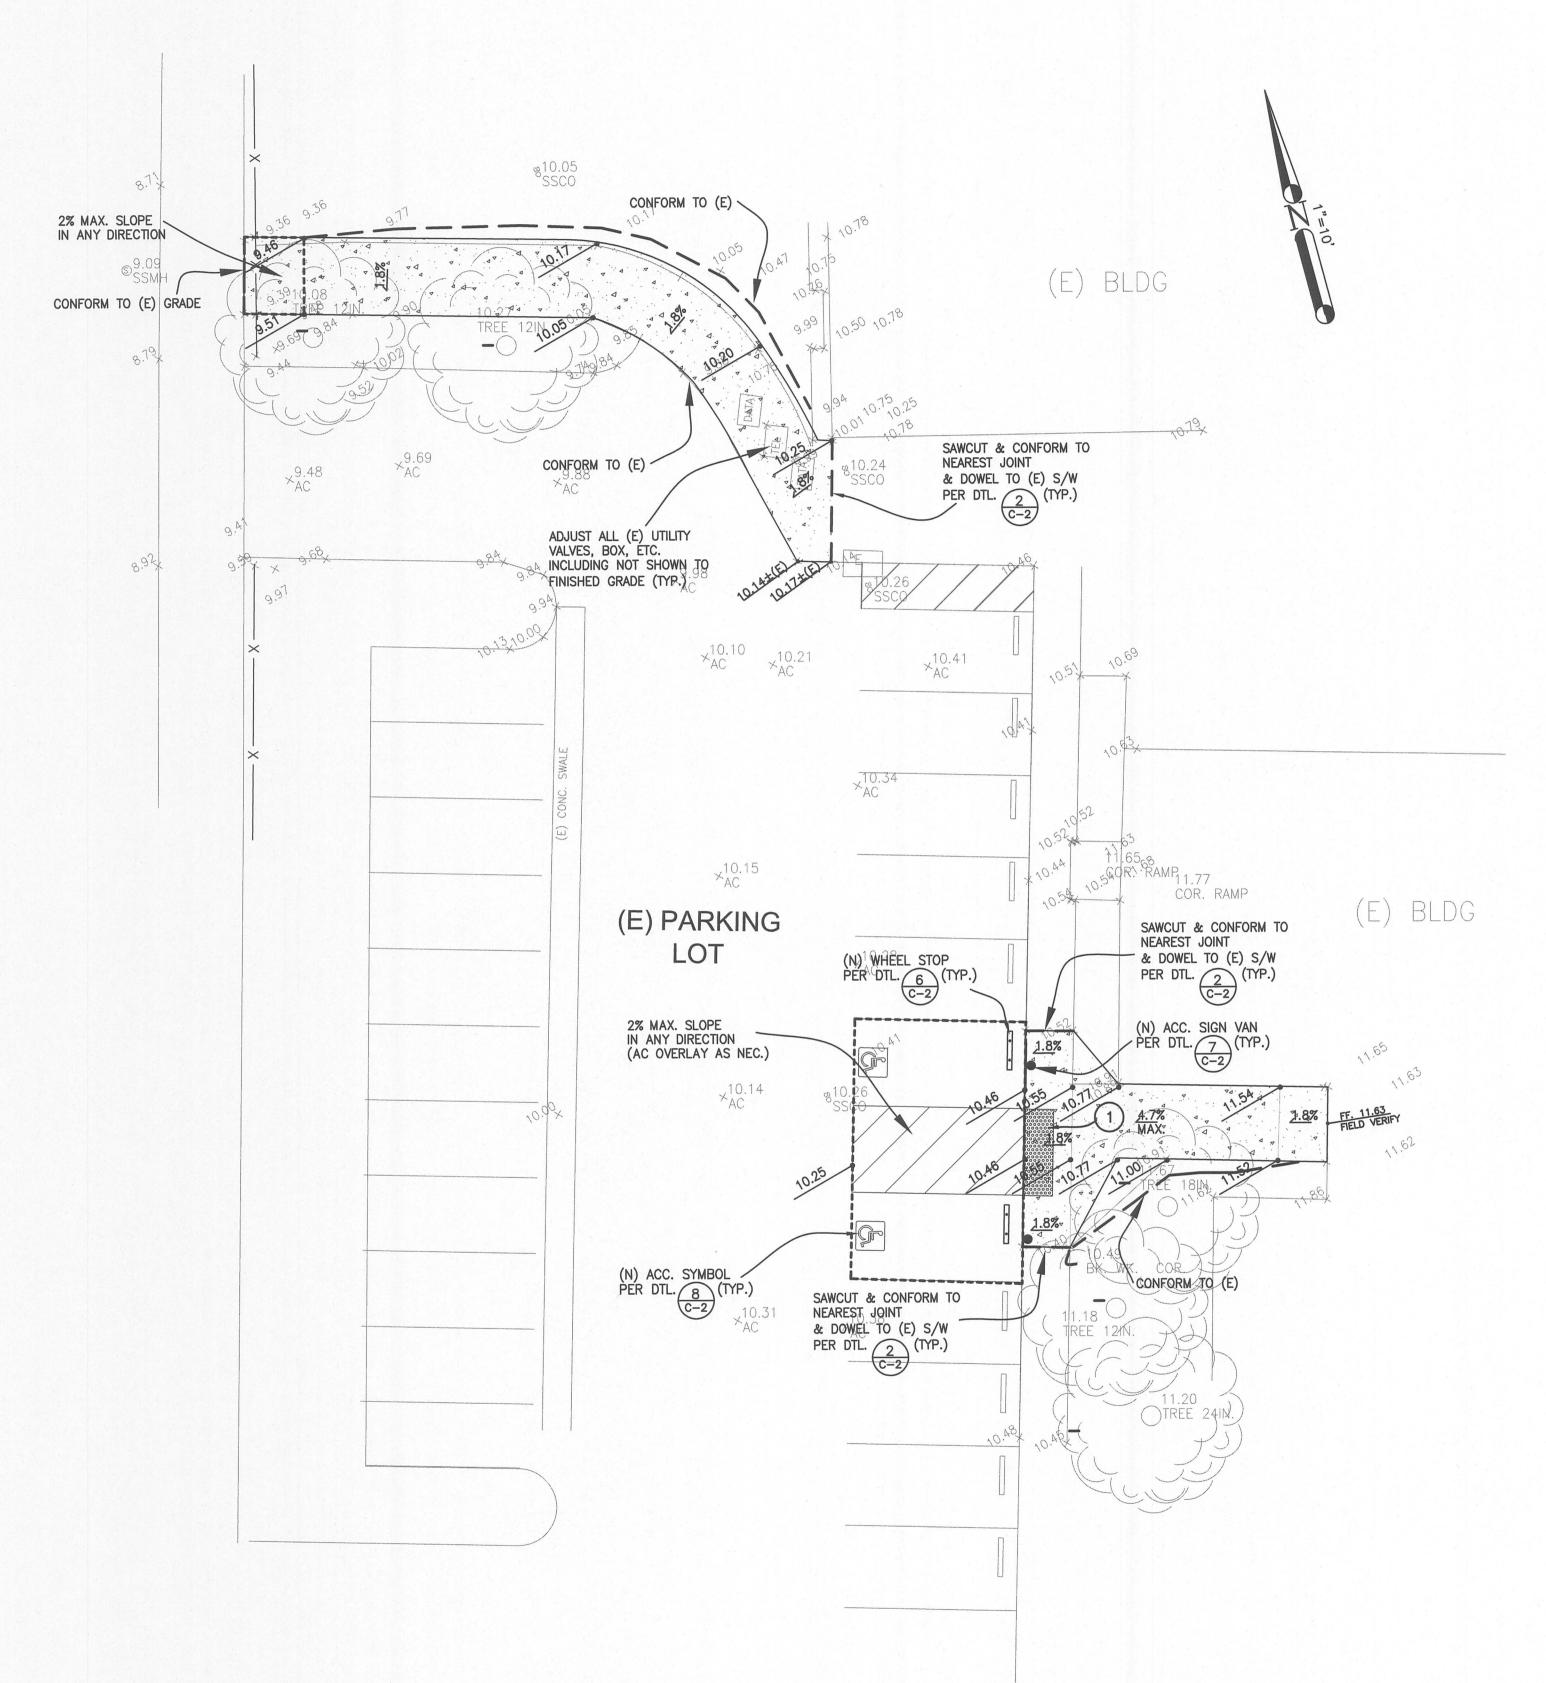

#### NOTES:

- 1. UNDERGROUND UTILITY LOCATIONS SHOWN HEREON WERE TAKEN FROM RECORD DATA. NO GUARANTEE IS MADE OR IMPLIED AS TO THE ACCURACY OF SUCH RECORD DATA. NO EXCAVATIONS WERE MADE TO CONFIRM LOCATIONS. CONTRACTORS SHALL CONTACT U.S.A. UNDERGROUND (1-800-227-2600) AND TO EXERCISE EXTREME CARE IN VERIFYING ALL LOCATIONS PRIOR TO COMMENCING EXCAVATIONS OR OTHER WORK WHICH MAY AFFECT THESE UTILITIES.
- 2. IRRIGATION LATERALS, PARKING LOT LIGHTING WIRING AND SIGNAL WIRING NOT SHOWN. VERIFY LOCATION BEFORE COMMENCING TRENCHING. REPLACE OR REPAIR IMMEDIATELY WHERE BROKEN TO PROVIDE UNINTERRUPTED SERVICE.
- 3. ALL FINISH GRADES SHOWN ARE TO TOP OF PAVEMENT NOT TOP OF CURB UNLESS NOTED OTHERWISE. TOP OF CURB ELEVATION IS 6" ABOVE TOP OF PAVEMENT UNLESS NOTED OTHERWISE.
- 4. GRADING CONFORM LINE AND MATCH POINTS [EXAMPLE: (39.05±(E)] TO EXISTING CONDITIONS ARE BASED ON ESTIMATED ELEVATIONS FROM AERIAL AND TOPOGRAPHIC SURVEYS. CONTRACTOR SHALL VERIFY ELEVATIONS AT CONFORM AND MATCH POINTS BEFORE GRADING TO ENSURE PROPER DRAINAGE AND SLOPES.
- 5. ALL CATCH BASINS SHALL BE CHRISTY V12 (12"x12") WITH TRAFFIC WEIGHT GRATES. WHEN PIPE SIZES ARE 10" OR GREATER USE CATCH BASIN CHRISTY U21 (24"x24"). UNLESS NOTED OTHERWISE. FOR CATCH BASINS IN WALKWAY AREAS, INCLUDING EXISTING CATCH BASINS, USE HEEL PROOF AND ADA GRATE BY GRATING PACIFIC (800) 491-7999 OR APPROVED ALTERNATE.
- 6. PRIOR TO CONNECTING TO EXISTING UTILITIES OR INSTALLING UPSTREAM UTILITIES, VERIFY LOCATION, SIZE, INVERT OR DEPTH AT POINT OF CONNECTION.
- 7. UTILITY ABANDONMENT/REMOVAL: DISCONNECT AND CAP PIPES AND SERVICES TO REMAIN. REMOVE ALL PORTIONS OF ALL UTILITIES WITHIN NEW BUILDING FOOTPRINT AND DISPOSE OF OFF-SITE. OTHERWISE ABANDON IN PLACE U.N.O.

**KEY NOTES:** 

INSTALL 36" WIDE BAND OF DETECTABLE WARNING TRUNCATED DOMES PER MFR'S. SPECS. USE YELLOW TRUNCATED DOMES PART NO. 3660IDRET2 BY ADA SOLUTIONS (800.372.0519) MEETING CBC SECTION 11B-705 OR APPROVED ALTERNATE. FINISH TO MATCH S/W.

NEW CONCRETE PAVING SECTION 4" CONC. W/ #4 @ 18" O.C.E.W. OVER 6" CL. II A.B., EXPANSION JOINTS @ 24' O.C. AND SCORED @ 4' O.C. SEE DTL. 4/C-2 WHERE (N) CONC. MEETS LANDSCAPE, (N) THICKENED EDGE CONC. PER DTL. 3/C-2 (TYP.) SEE DTL. 5/C-2 WHERE (N) CONC. MEETS BUILDING SEE DTL. 2/C-2 WHERE (N) CONC. MEETS (E) CONC. (TYP.)

TREE W/SIZE

PAVING LEGEND

NOTES (CONT'D):

FINISHED GRADE (TYP.)

PORTIONS REMOVED:

REMAIN & REPAIR IN KIND

TO REMAIN.

8. NOTIFY THE ENGINEER IMMEDIATELY OF ANY UTILITIES ENCOUNTERED THAT

ARE NOT SHOWN ON THE DRAWINGS. PRESERVE AND REPAIR ANY

9. CONTRACTOR IS RESPONSIBLE FOR COORDINATING ALL CROSSINGS OF

NEW UTILITIES WITH EACH OTHER, AND WITH EXISTING UTILITIES.

NEW UTILITIES. NOTIFY THE ENGINEER IMMEDIATELY OF ANY

WATER & DRY UTILITIES TO ENSURE NO CONFLICTS.

MINIMUM OF 6" INTO (E) CONCRETE WITH EPOXY.

VERIFY EXISTING PIPE LOCATION AND INVERT PRIOR TO INSTALLING

DISCREPANCIES OR DEVIATIONS. INSTALL GRAVITY UTILITIES BEFORE

10. SAWCUT, REMOVE, & REPLACE EXISTING PAVEMENT, CURBS, SIDEWALKS, &

11. ADJUST ALL (E) UTILITY VALVES, BOX, ETC. INCLUDING NOT SHOWN TO

SURVEY CONTROL POINTS. A LICENSED LAND SURVEYOR SHALL REPAIR AND OR REPLACE ANY SURVEY CONTROL POINTS THAT ARE DISPLACED OR

13. FIELD VERIFY EXTENT OF (E) IRRIGATION. MAINTAIN EXISTING ACTIVE SYSTEM

A. NON-PRESSURE LINES: CUT & CAP AT LIMIT OF WORK

PVC BALL VALVE IN CONC. BOX AT LIMIT OF WORK.

14. PROTECT (E) IRRIGATION & PLANTING IN PLACE, REPAIR AS REQUIRED

IN-KIND DUE TO CONSTRUCTION DAMAGE. COORDINATE W/ ARCHITECT.

B. PRESSURIZED MAIN LINES: CUT, CAP & STUB OUT WITH SCH 80

C. PLACE STUB OUTS & BOXES IN ADJACENT EXISTING AREA TO

12. CONTRACTOR IS RESPONSIBLE FOR PRESERVING & PROTECTING ALL

LANDSCAPING TO MATCH (E) AS NECESSARY TO INSTALL NEW UTILITIES AS

12" O.C. ON THE CENTER OF THE (N) CONCRETE SECTION AND EMBED A

SHOWN. FOR REPLACING CONCRETE PAVEMENT, USE 18" LONG, #4 DOWELS @

UTILITIES THAT ARE DAMAGED AND THAT ARE TO REMAIN.

**LEGEND** PROPOSED DESCRIPTION PROPERTY LINE CONCRETE CURB CONCRETE CURB & GUTTER SAWCUT/CONFORM LINE HEADER BOARD TRAFFIC MARKINGS SIGN 1 ACCESSIBLE RAMP FIRE HYDRANT EDGE OF PAVEMENT  $\times$   $\times$   $\times$ **FENCE** STORM DRAIN & SIZE GRADE BREAK CONTOUR LINE CLEAN OUT TO GRADE CATCH BASIN AREA DRAIN DRAINAGE ARROW ~~> O-BFP O-BFP ● ● BFP BACK FLOW PREVENTOR TELE TELEPHONE BOX U UNKNOWN UTILITY BOX POWER (ELECTRICAL) BOX WATER METER WATER BOX VALLEY GUTTER SPOT ELEVATION


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Consultant Seal

# **BRIC** Engineering


1475 South Bascom Ave., Suite 202 Campbell, CA 95008-0629 Tel. (408) 241-5494

BRIO JOB NO.: SCOE1708

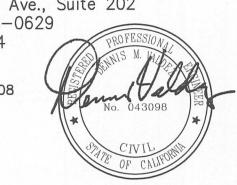

Legend

Key Plan

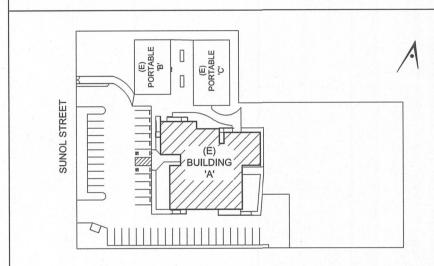

**Project Title** 

# SUNOL COMMUNITY SCHOOL **RESTROOMS UPGRADE**


258 SUNOL STREET SAN JOSE, CA 95126

SANTA CLARA COUNTY OFFICE OF EDUCATION

No	Revisions/Submissions	Date
110	Trevisions/edstriissions	54.0
1	DSA SUBMITTAL	06/28/2017
2	DSA BACKCHECK SUBMITTAL	09/28/2017
Drawi	ng Title	

GRADING & UTILITY PLAN

Regulatory Agency Approval

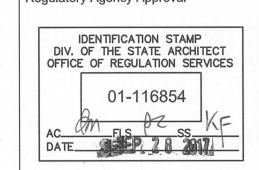




File Number Drawing No


**Application Number** 


Project No. 06307

06/27/2017

C-1

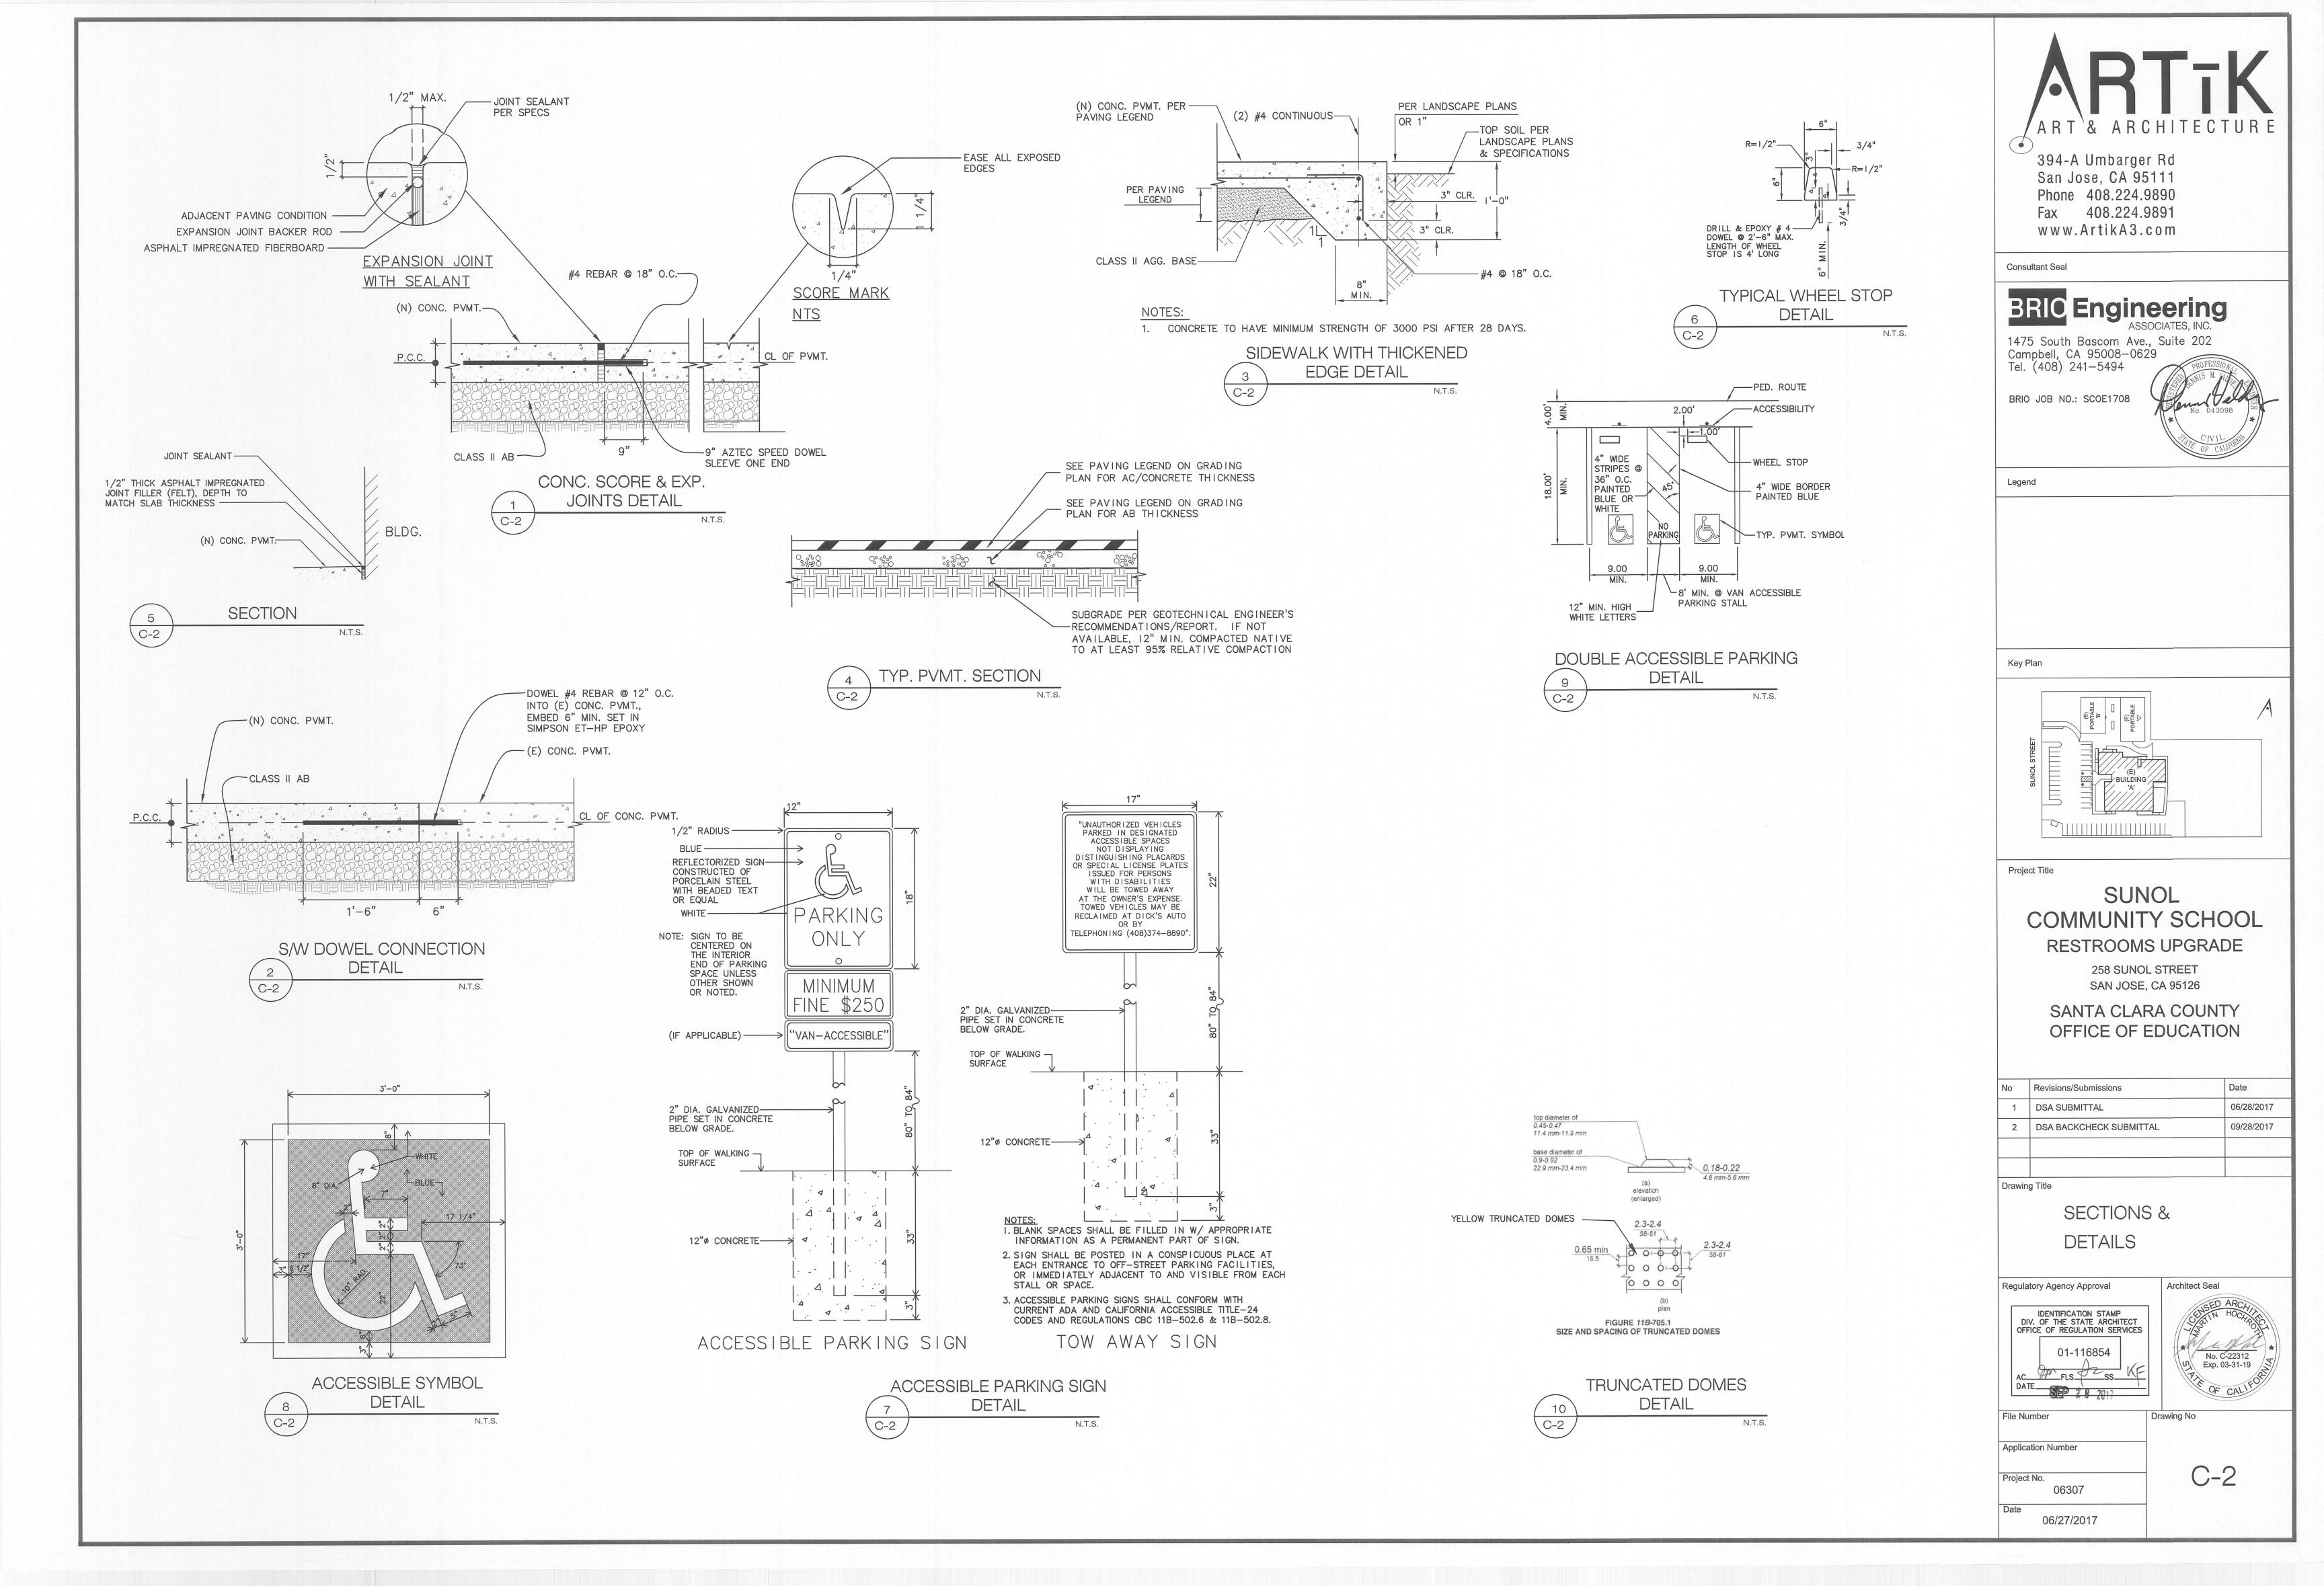

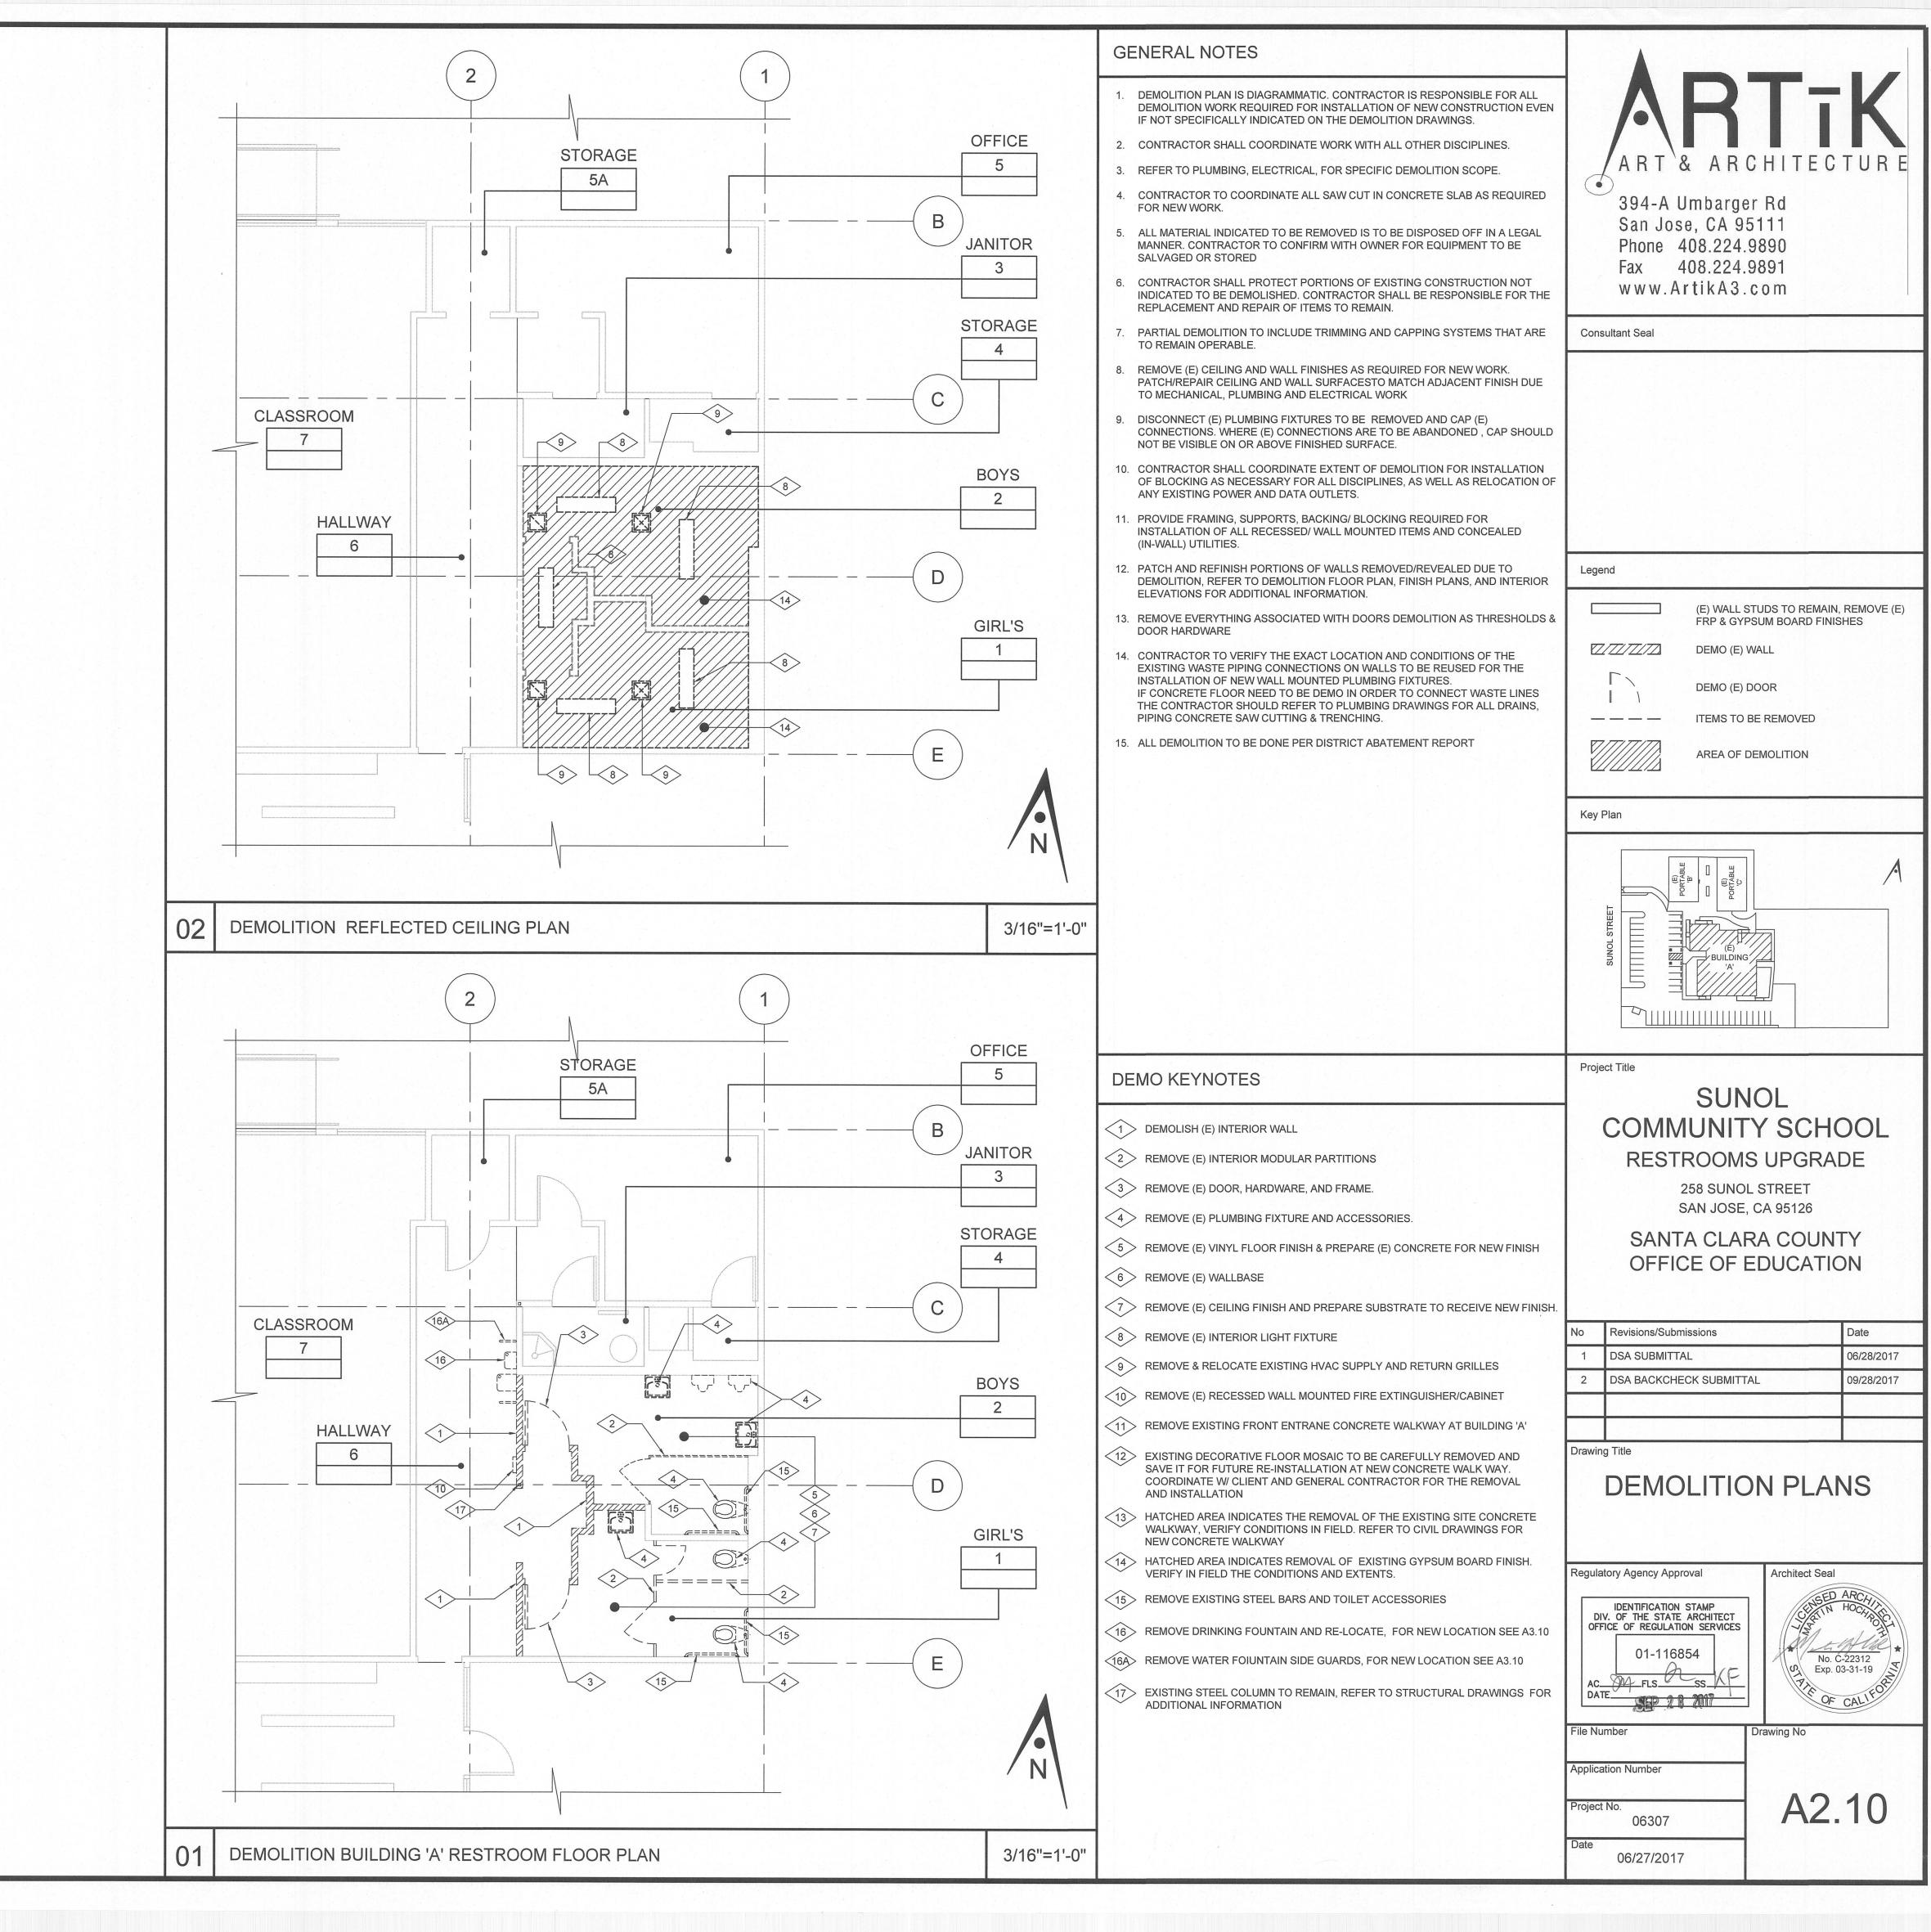

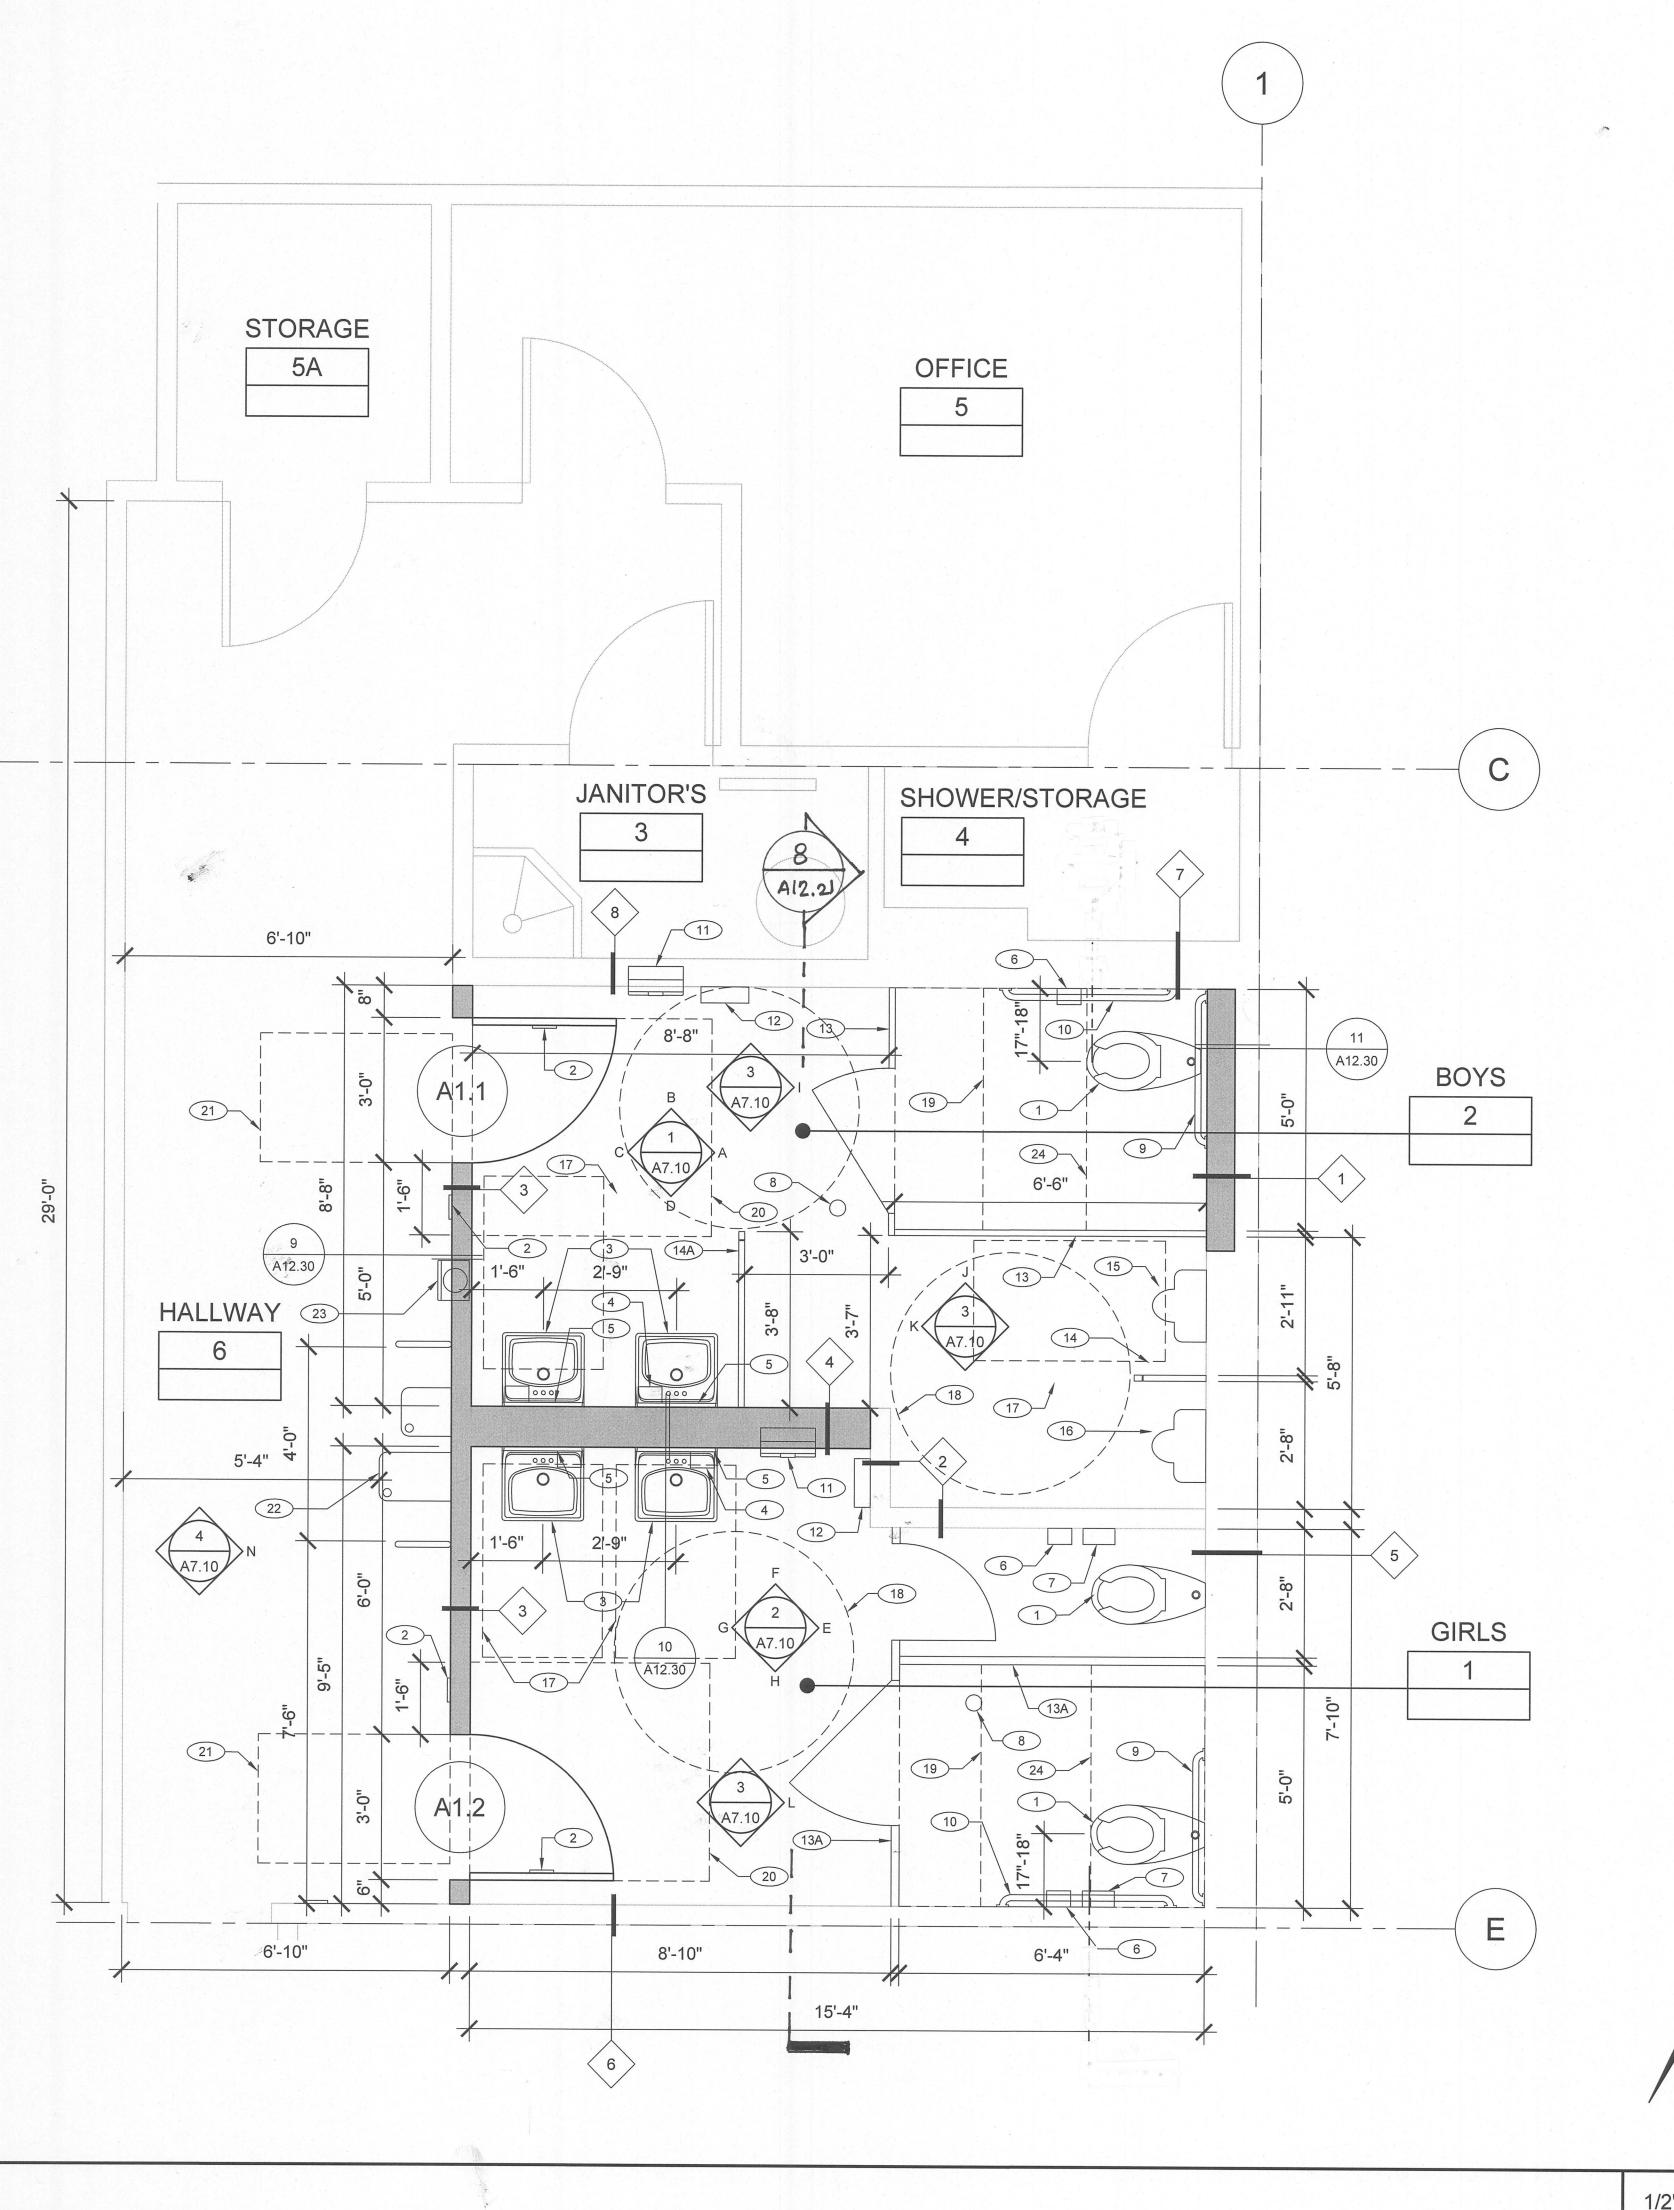

#### **GENERAL NOTES**

- 1. CONTRACTOR SHALL COORDINATE WORK WITH ALL OTHER DISCIPLINES.
- 2. CONTRACTOR TO REVIEW AS BUILT DRAWINGS FOR REFERENCE.
- 3. REFER TO INTERIOR ELEVATIONS, REFLECTED CEILING PLAN, FINISH FLOOR PLAN, SCHEDULES AND DETAILS FOR ADDITIONAL INFORMATION.
- 4. REFER TO DOOR SCHEDULE ON SHEET A10.10 AND SPECIFICATIONS FOR DOOR HARDWARE AND WINDOW SCHEDULE FOR ADDITIONAL NOTES AND INFORMATION.
- 5. PROVIDE FRAMING, SUPPORTS, BACKING/ BLOCKING REQUIRED FOR INSTALLATION OF ALL RECESSED/ WALL MOUNTED ITEMS AND CONCEALED (IN-WALL) UTILITIES.
- 6. ALL SIGNAGE MUST BE FIELD INSPECTED PER 2016 CBC 11B-703.1.1
- 7. PAINT ALL NEW AND EXISTING RESTROOMS SURFACES INCLUDING, BUT NOT LIMITED TO, WALLS DOORS AND TRIMS.
- 8. PROVIDE ACCESS DOORS IN HARDLID AREAS AND WHERE NEEDED PER CBC CODE AND SPECIFICATIONS. GC SHALL COORDINATE WITH MECHANICAL & PLUMBING DRAWINGS. EXACT LOCATION TO BE COORDINATED WITH ARCHITECT.
- 9. PROVIDE SOUND ATTENUATION BATT INSULATION IN CEILING AND WALLS
- 10. NO EXPOSED CONDUITS ARE ALLOWED, ALL CONDUITS MUST BE INSIDE STUD WALLS, SEE ELECTRICAL DRAWINGS FOR ADDITIONAL INFORMATION
- 11. TRENCHING IN SLAB IS REQUIRED TO ACCOMMODATE NEW PLUMBING FIXTURES. REFER TO FLOOR PLAN.

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Consultant Seal

Legend

(E) WALLS TO REMAIN

2X WALL


DOOR TYPE, REFER TO SHEET A10.10

WALL TYPE, REFER TO SHEET A12.30

Key Plan

#### **KEYNOTES**

- 01 ACCESSIBLE WALL MOUNT WATER CLOSET W/ FLUSHOMETER
- AND 60"X56" CLEAR SPACE. SEE PLUMBING DWGS. 02 RESTROOM DOOR SIGN. SEE DETAIL 3/A12.20
- 03 ACCESSIBLE LAVATORY W/ 30"X48" CLEAR SPACE. SEE DET. 2/A12.20, REFER TO PLUMBING DWGS.
- 04 SOAP DISPENSER
- 05 18"x36" MIRROR MOUNTED ABOVE LAVATORY MOUNT BOTTOM OF REFLECTIVE SURFACE 40" MAX. A.F.F.
- 06 SURFACE MOUNT TOILET PAPER DISPENSER.
- 07 SURFACE MOUNT SANITARY DISPOSAL
- 08 EXISTING FLOOR DRAIN. SEE PLUMBING DWGS.
- 09 36" GRAB BAR, MAINTAIN 1-1/2" CLEAR BELOW GRAB BAR.
- 10 42" GRAB BAR, MAINTAIN 1-1/2" CLEAR BELOW GRAB BAR.
- (11) COMBINATION SEMI-RECESSED WASTE AND PAPER TOWEL DISPENSER
- 12 ELECTRIC HAND DRYER, 4" MAX. PROJECTION
- 13 TOILET COMPARTMENTS (PARTITIONS) SEE ELEVATIONS; I,J & K AT 3/A7.10 PROVIDE 12" CLEAR BELOW PARTITIONS PER CBC 11B-604.8.1.4.
- TOILET COMPARTMENTS (PARTITIONS) SEE ELEVATIONS, L & M AT 3/A7.10 PROVIDE 12" CLEAR BELOW PARTITIONS PER CBC 11B-604.8.1.4.
- 14 URINAL PARTITION
- 14A SCREEN PARTITION
- 15 WALL MOUNTED URINAL WITH FLUSHOMETER
- 16 ACCESSIBLE WALL MOUNT URINAL W/ FLUSHOMETER AND 30" X 48" CLEAR SPACE. SEE PLUMBING DWGS.
- 17 30" X 48" CLEAR SPACE
- 18 5'-0" CLEAR SPACE
- 19 60" X 56" CLEAR SPACE
- 20 60" X 54" CLEAR SPACE
- (21) 48" X 32" CLEAR SPACE
- 22 RELOCATED ACCESSIBLE DRINKING FOUNTAIN SEE 6/ A12.21
- 23 RECESSED WALL MOUNTED FIRE EXTINGUISHER, 2A:10B:C, & CABINET WITH VALID CERTIFICATION TAG ATTACHED.
- 24 48" X 60" CLEAR

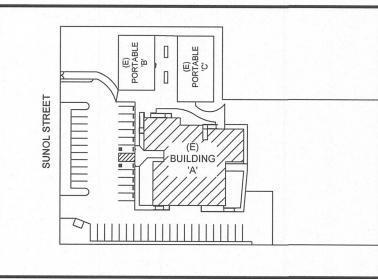

Project Title

# SUNOL COMMUNITY SCHOOL RESTROOMS UPGRADE

258 SUNOL STREET SAN JOSE, CA 95126

SANTA CLARA COUNTY OFFICE OF EDUCATION

No	Revisions/Submissions	Date
1	DSA SUBMITTAL	06/28/2017
2	DSA BACKCHECK SUBMITTAL	09/28/2017

Drawing Title

# **ENLARGED** RESTROOMS PLAN

Regulatory Agency Approval

IDENTIFICATION STAMP
DIV. OF THE STATE ARCHITECT
OFFICE OF REGULATION SERVICES FLS DESS NE SEP 28 2017

06/27/2017



ile Number


Application Number


A3.10 Project No. 06307

Drawing No

1/2"=1'-0"

ENLARGED RESTROOMS FLOOR PLAN

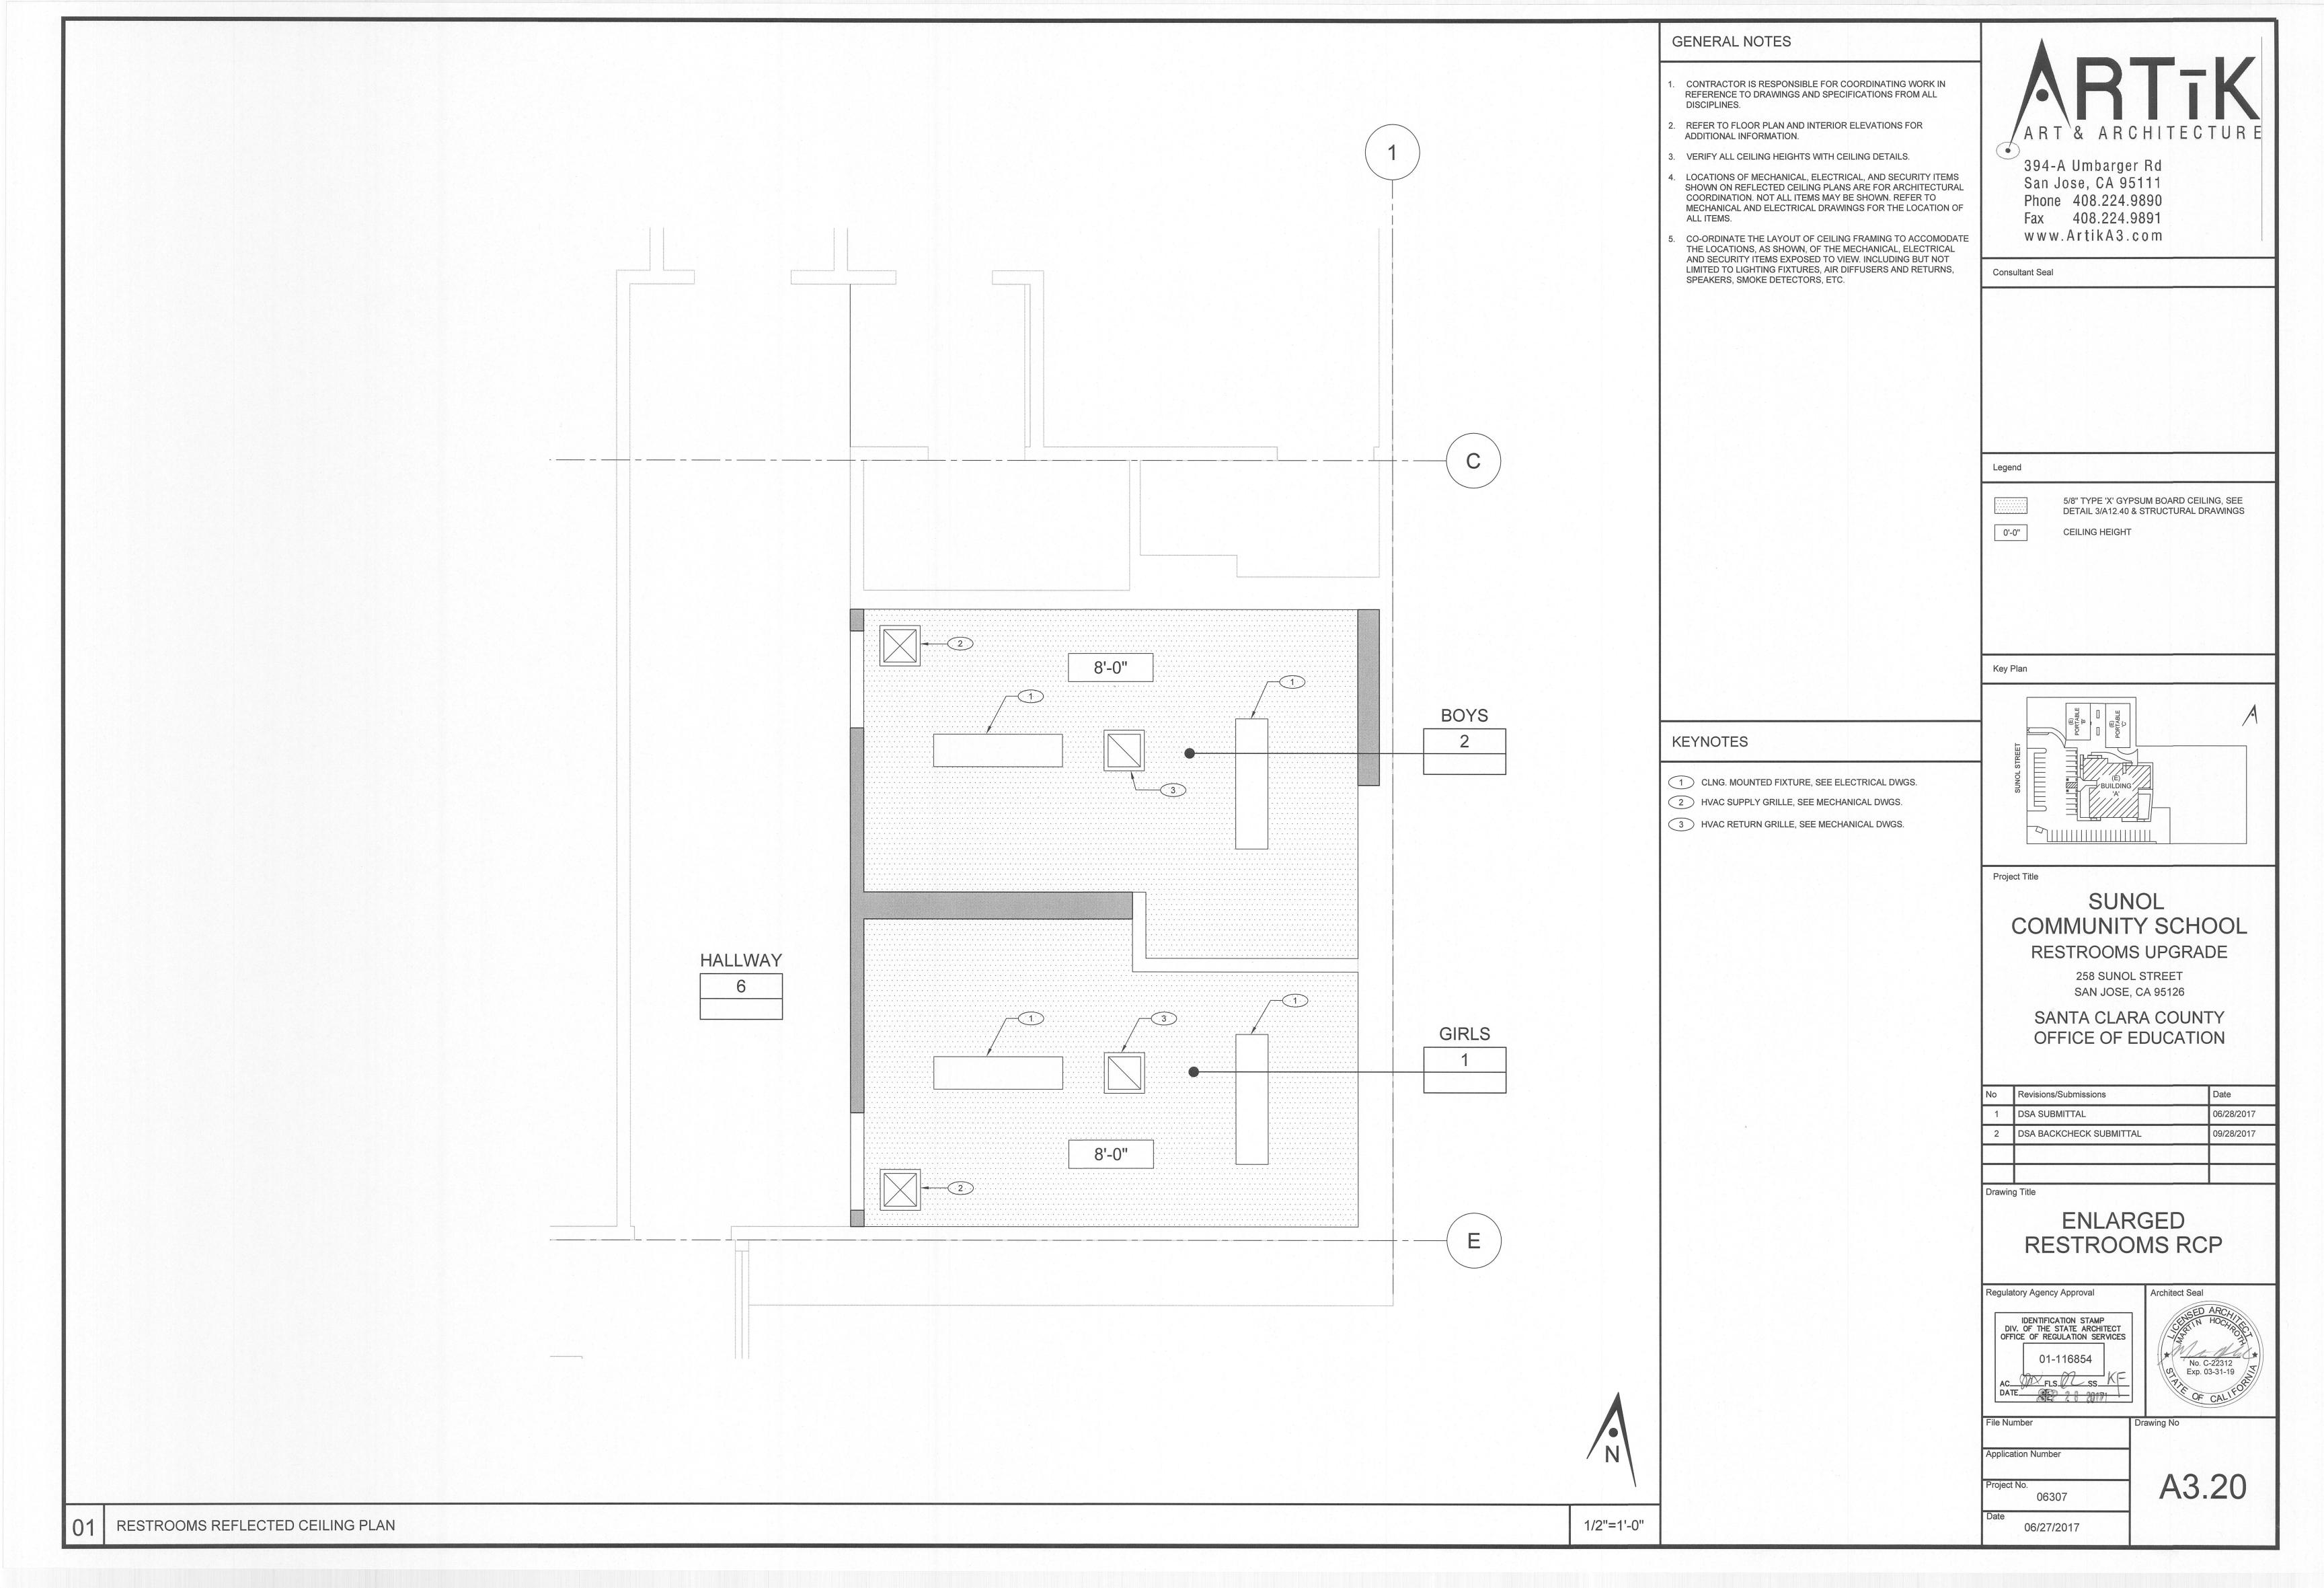

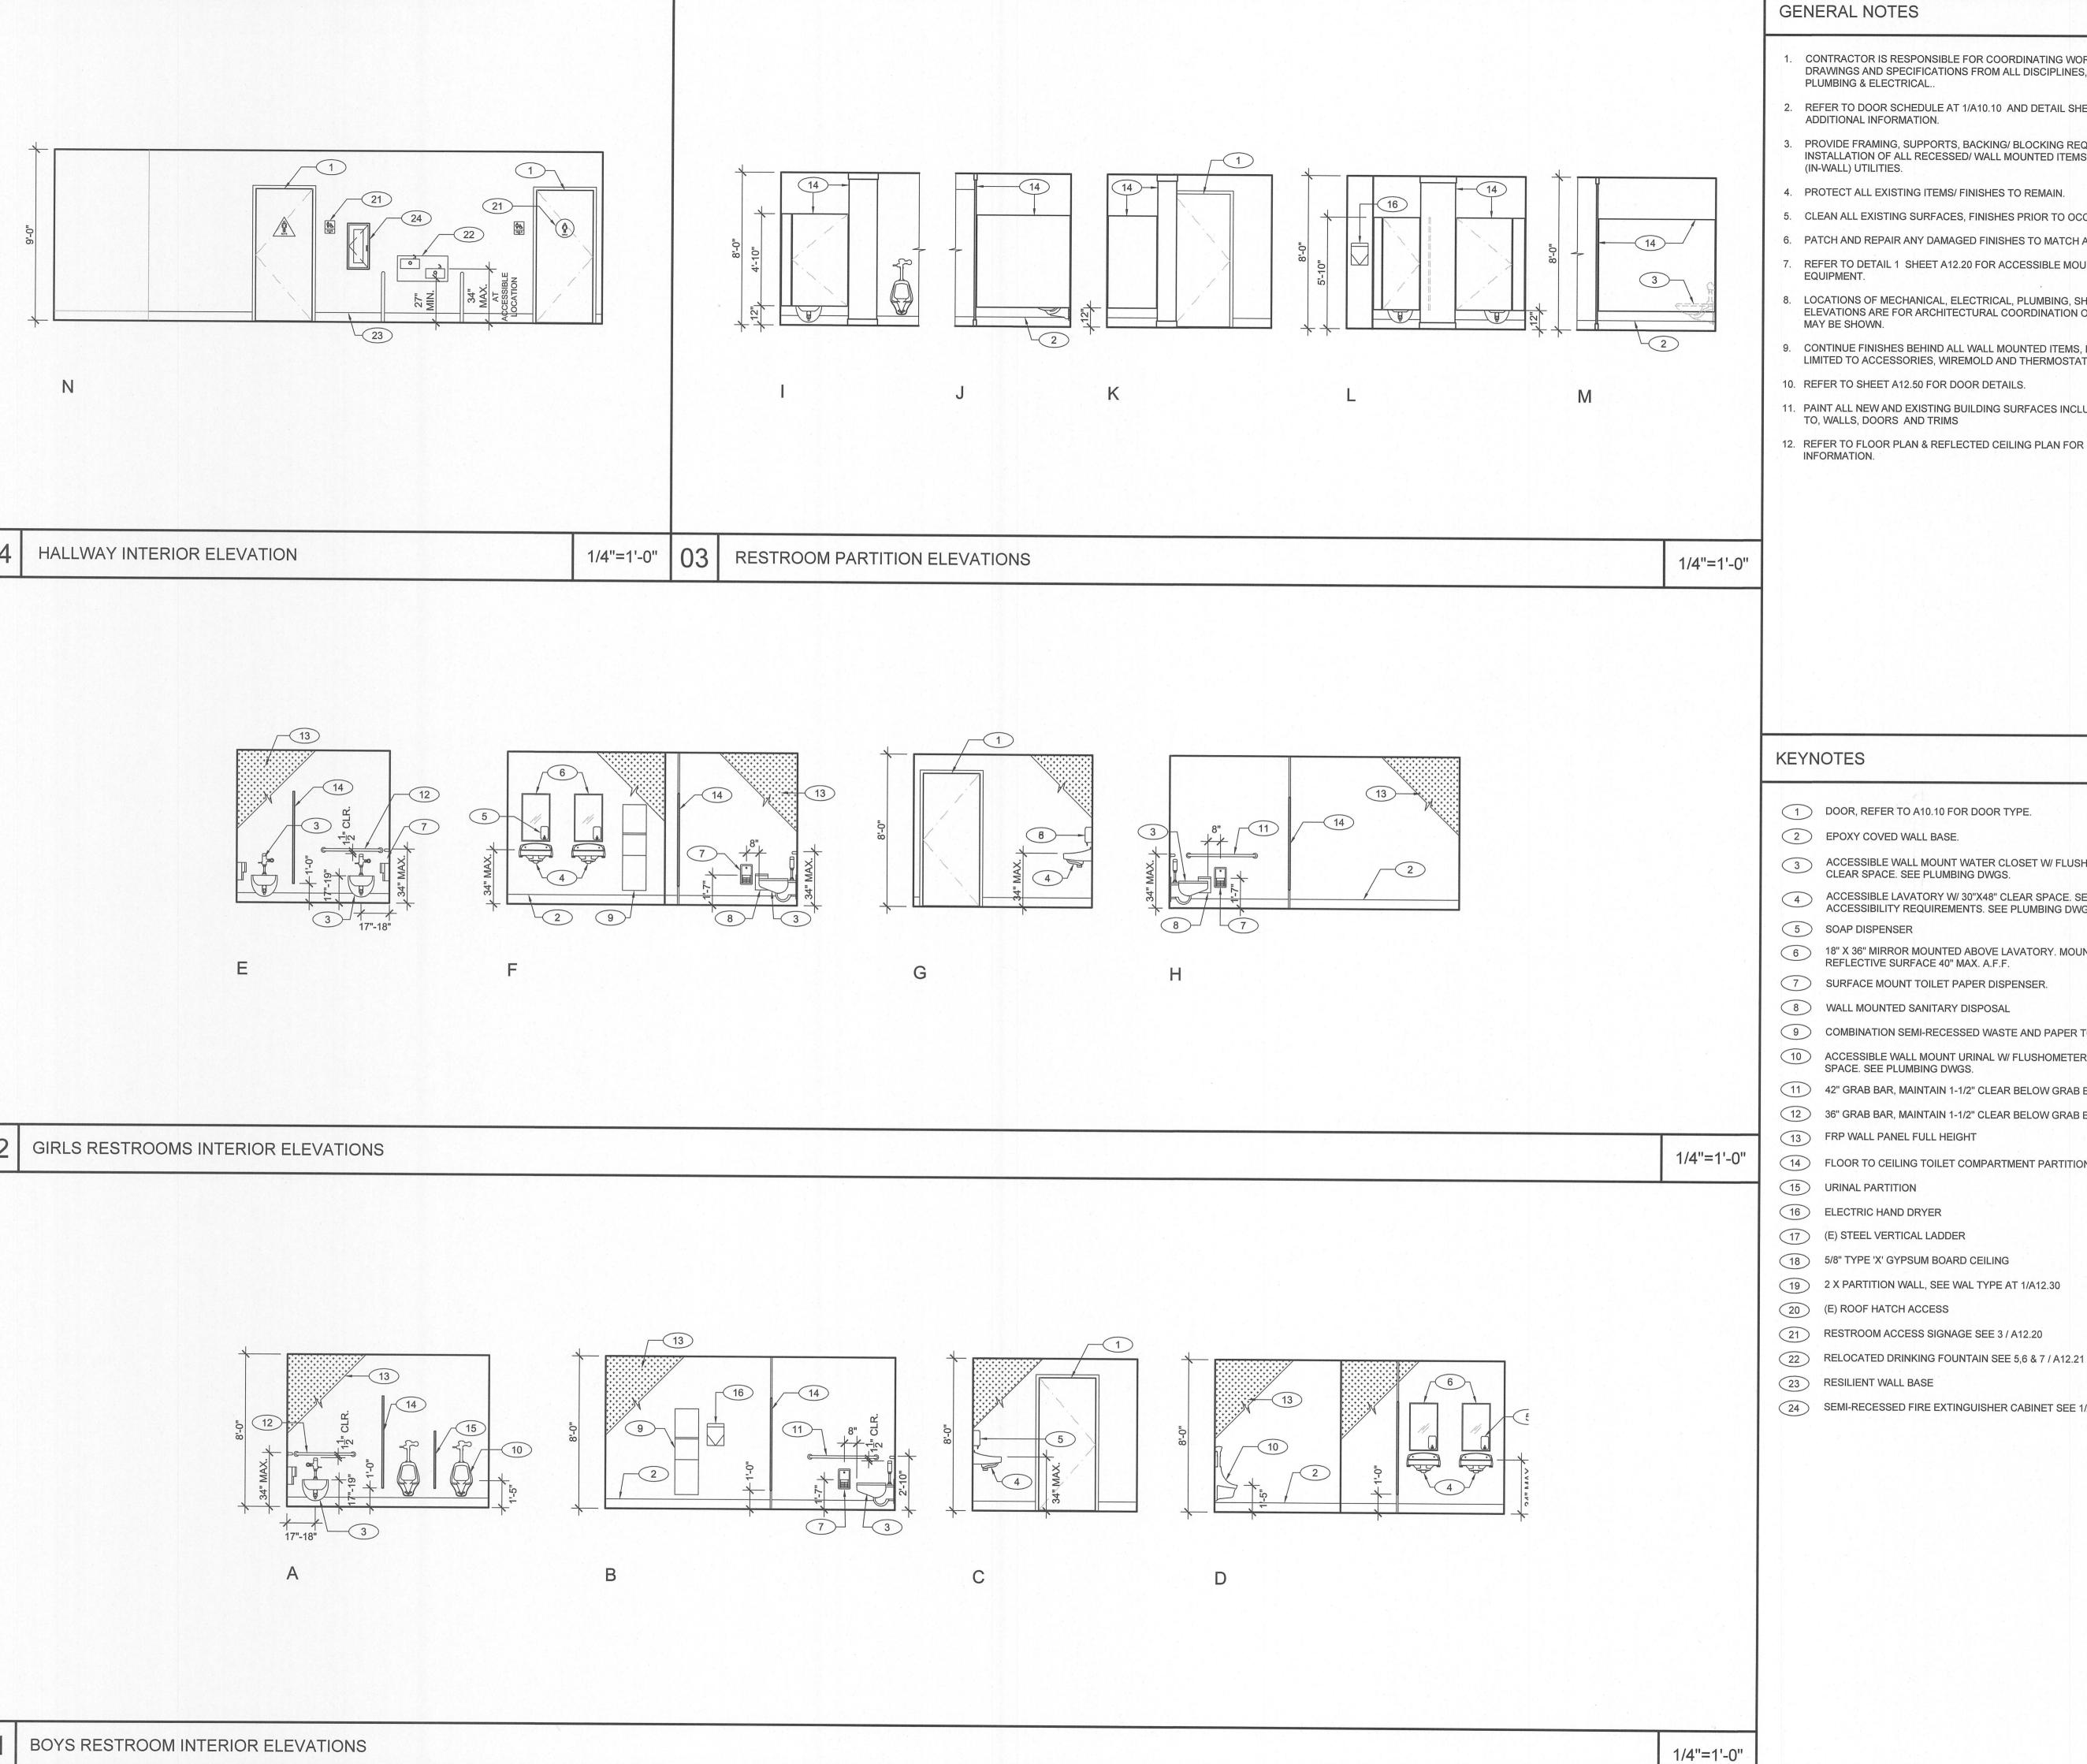

- 1. CONTRACTOR IS RESPONSIBLE FOR COORDINATING WORK IN REFERENCE TO DRAWINGS AND SPECIFICATIONS FROM ALL DISCIPLINES, MECHANICAL, PLUMBING & ELECTRICAL..
- 2. REFER TO DOOR SCHEDULE AT 1/A10.10 AND DETAIL SHEETS A12.20 & A12.21 FOR
- 3. PROVIDE FRAMING, SUPPORTS, BACKING/ BLOCKING REQUIRED FOR INSTALLATION OF ALL RECESSED/ WALL MOUNTED ITEMS AND CONCEALED
- 4. PROTECT ALL EXISTING ITEMS/ FINISHES TO REMAIN.
- 5. CLEAN ALL EXISTING SURFACES, FINISHES PRIOR TO OCCUPATION.
- 6. PATCH AND REPAIR ANY DAMAGED FINISHES TO MATCH ADJACENT FINISH.
- 7. REFER TO DETAIL 1 SHEET A12.20 FOR ACCESSIBLE MOUNTING HEIGHTS OF
- 8. LOCATIONS OF MECHANICAL, ELECTRICAL, PLUMBING, SHOWN ON INTERIOR ELEVATIONS ARE FOR ARCHITECTURAL COORDINATION ONLY. NOT ALL ITEMS
- 9. CONTINUE FINISHES BEHIND ALL WALL MOUNTED ITEMS, INCLUDING BUT NOT LIMITED TO ACCESSORIES, WIREMOLD AND THERMOSTATS.
- 10. REFER TO SHEET A12.50 FOR DOOR DETAILS.
- 11. PAINT ALL NEW AND EXISTING BUILDING SURFACES INCLUDING, BUT NOT LIMITED TO, WALLS, DOORS AND TRIMS
- 12. REFER TO FLOOR PLAN & REFLECTED CEILING PLAN FOR ADDITIONAL

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Consultant Seal

Legend

GYPSUM BOARD, PAINT

Key Plan

FRP WALLBOARD

1 DOOR, REFER TO A10.10 FOR DOOR TYPE.

3 ACCESSIBLE WALL MOUNT WATER CLOSET W/ FLUSHOMETER AND 30"X48" CLEAR SPACE. SEE PLUMBING DWGS.

ACCESSIBLE LAVATORY W/ 30"X48" CLEAR SPACE. SEE DET. 2/A20.10 FOR ACCESSIBILITY REQUIREMENTS. SEE PLUMBING DWGS.

6 18" X 36" MIRROR MOUNTED ABOVE LAVATORY. MOUNT BOTTOM OF REFLECTIVE SURFACE 40" MAX. A.F.F.

7 SURFACE MOUNT TOILET PAPER DISPENSER.

8 WALL MOUNTED SANITARY DISPOSAL

9 COMBINATION SEMI-RECESSED WASTE AND PAPER TOWEL DISPENSER

ACCESSIBLE WALL MOUNT URINAL W/ FLUSHOMETER AND 30" X 48" CLEAR SPACE. SEE PLUMBING DWGS.

11 42" GRAB BAR, MAINTAIN 1-1/2" CLEAR BELOW GRAB BAR.

12 36" GRAB BAR, MAINTAIN 1-1/2" CLEAR BELOW GRAB BAR.

13 FRP WALL PANEL FULL HEIGHT

14 FLOOR TO CEILING TOILET COMPARTMENT PARTITION


17 (E) STEEL VERTICAL LADDER

18 5/8" TYPE 'X' GYPSUM BOARD CEILING

19 2 X PARTITION WALL, SEE WAL TYPE AT 1/A12.30

20 (E) ROOF HATCH ACCESS

24 SEMI-RECESSED FIRE EXTINGUISHER CABINET SEE 1/A12.20

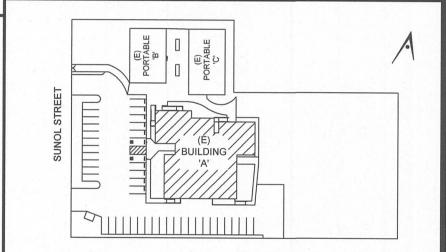

Project Title

SUNOL COMMUNITY SCHOOL RESTROOMS UPGRADE

> 258 SUNOL STREET SAN JOSE, CA 95126


SANTA CLARA COUNTY OFFICE OF EDUCATION

No	Revisions/Submissions	Date
1	DSA SUBMITTAL	06/28/2017
2	DSA BACKCHECK SUBMITTAL	09/28/2017

Drawing Title

**BUILDING A** INTERIOR **ELEVATIONS** 

Regulatory Agency Approval

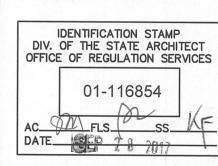

No. C-22312 Exp. 03-31-19

Architect Seal


File Number

Application Number

06307

A7.10

Drawing No

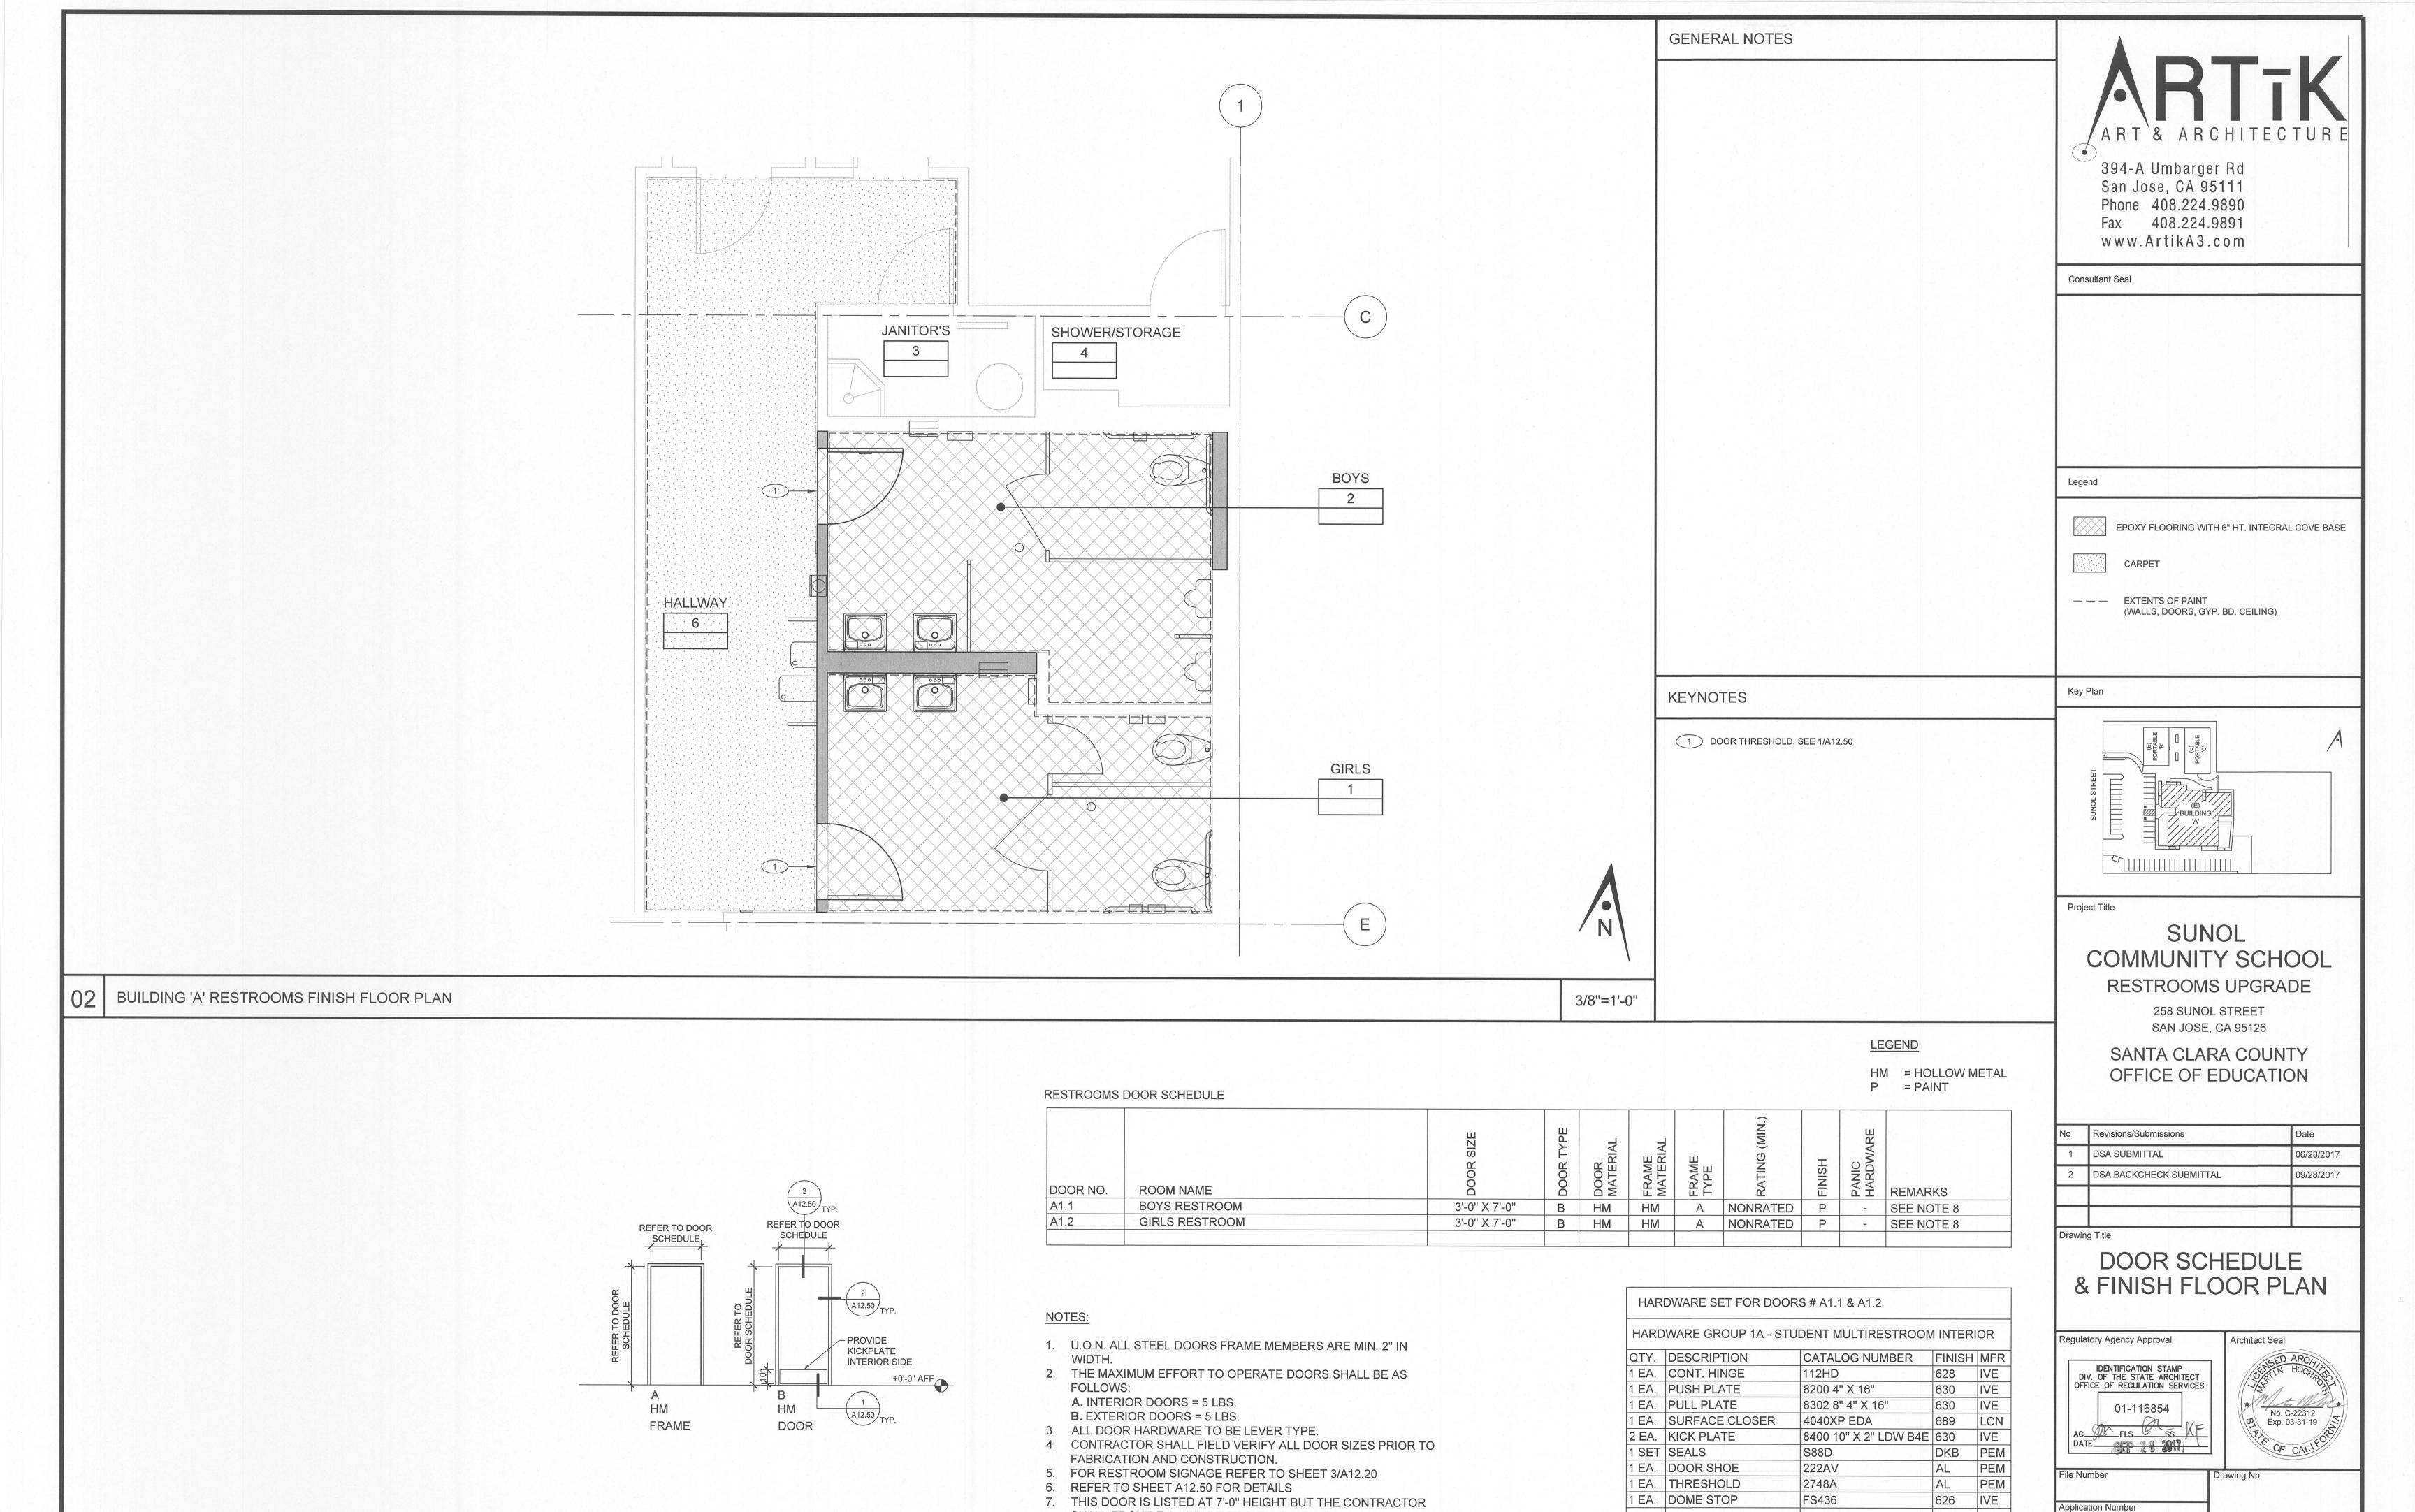


SHALL PROVIDE A 1/2" UNDERCUT FOR VENTILATION PURPOSES.


BUILDING 'A' RESTROOMS - DOOR SCHEDULE, FRAME / DOOR TYPE


1/4"=1'-0"


06/27/2017


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#### STRUCTURAL SPECIFICATIONS

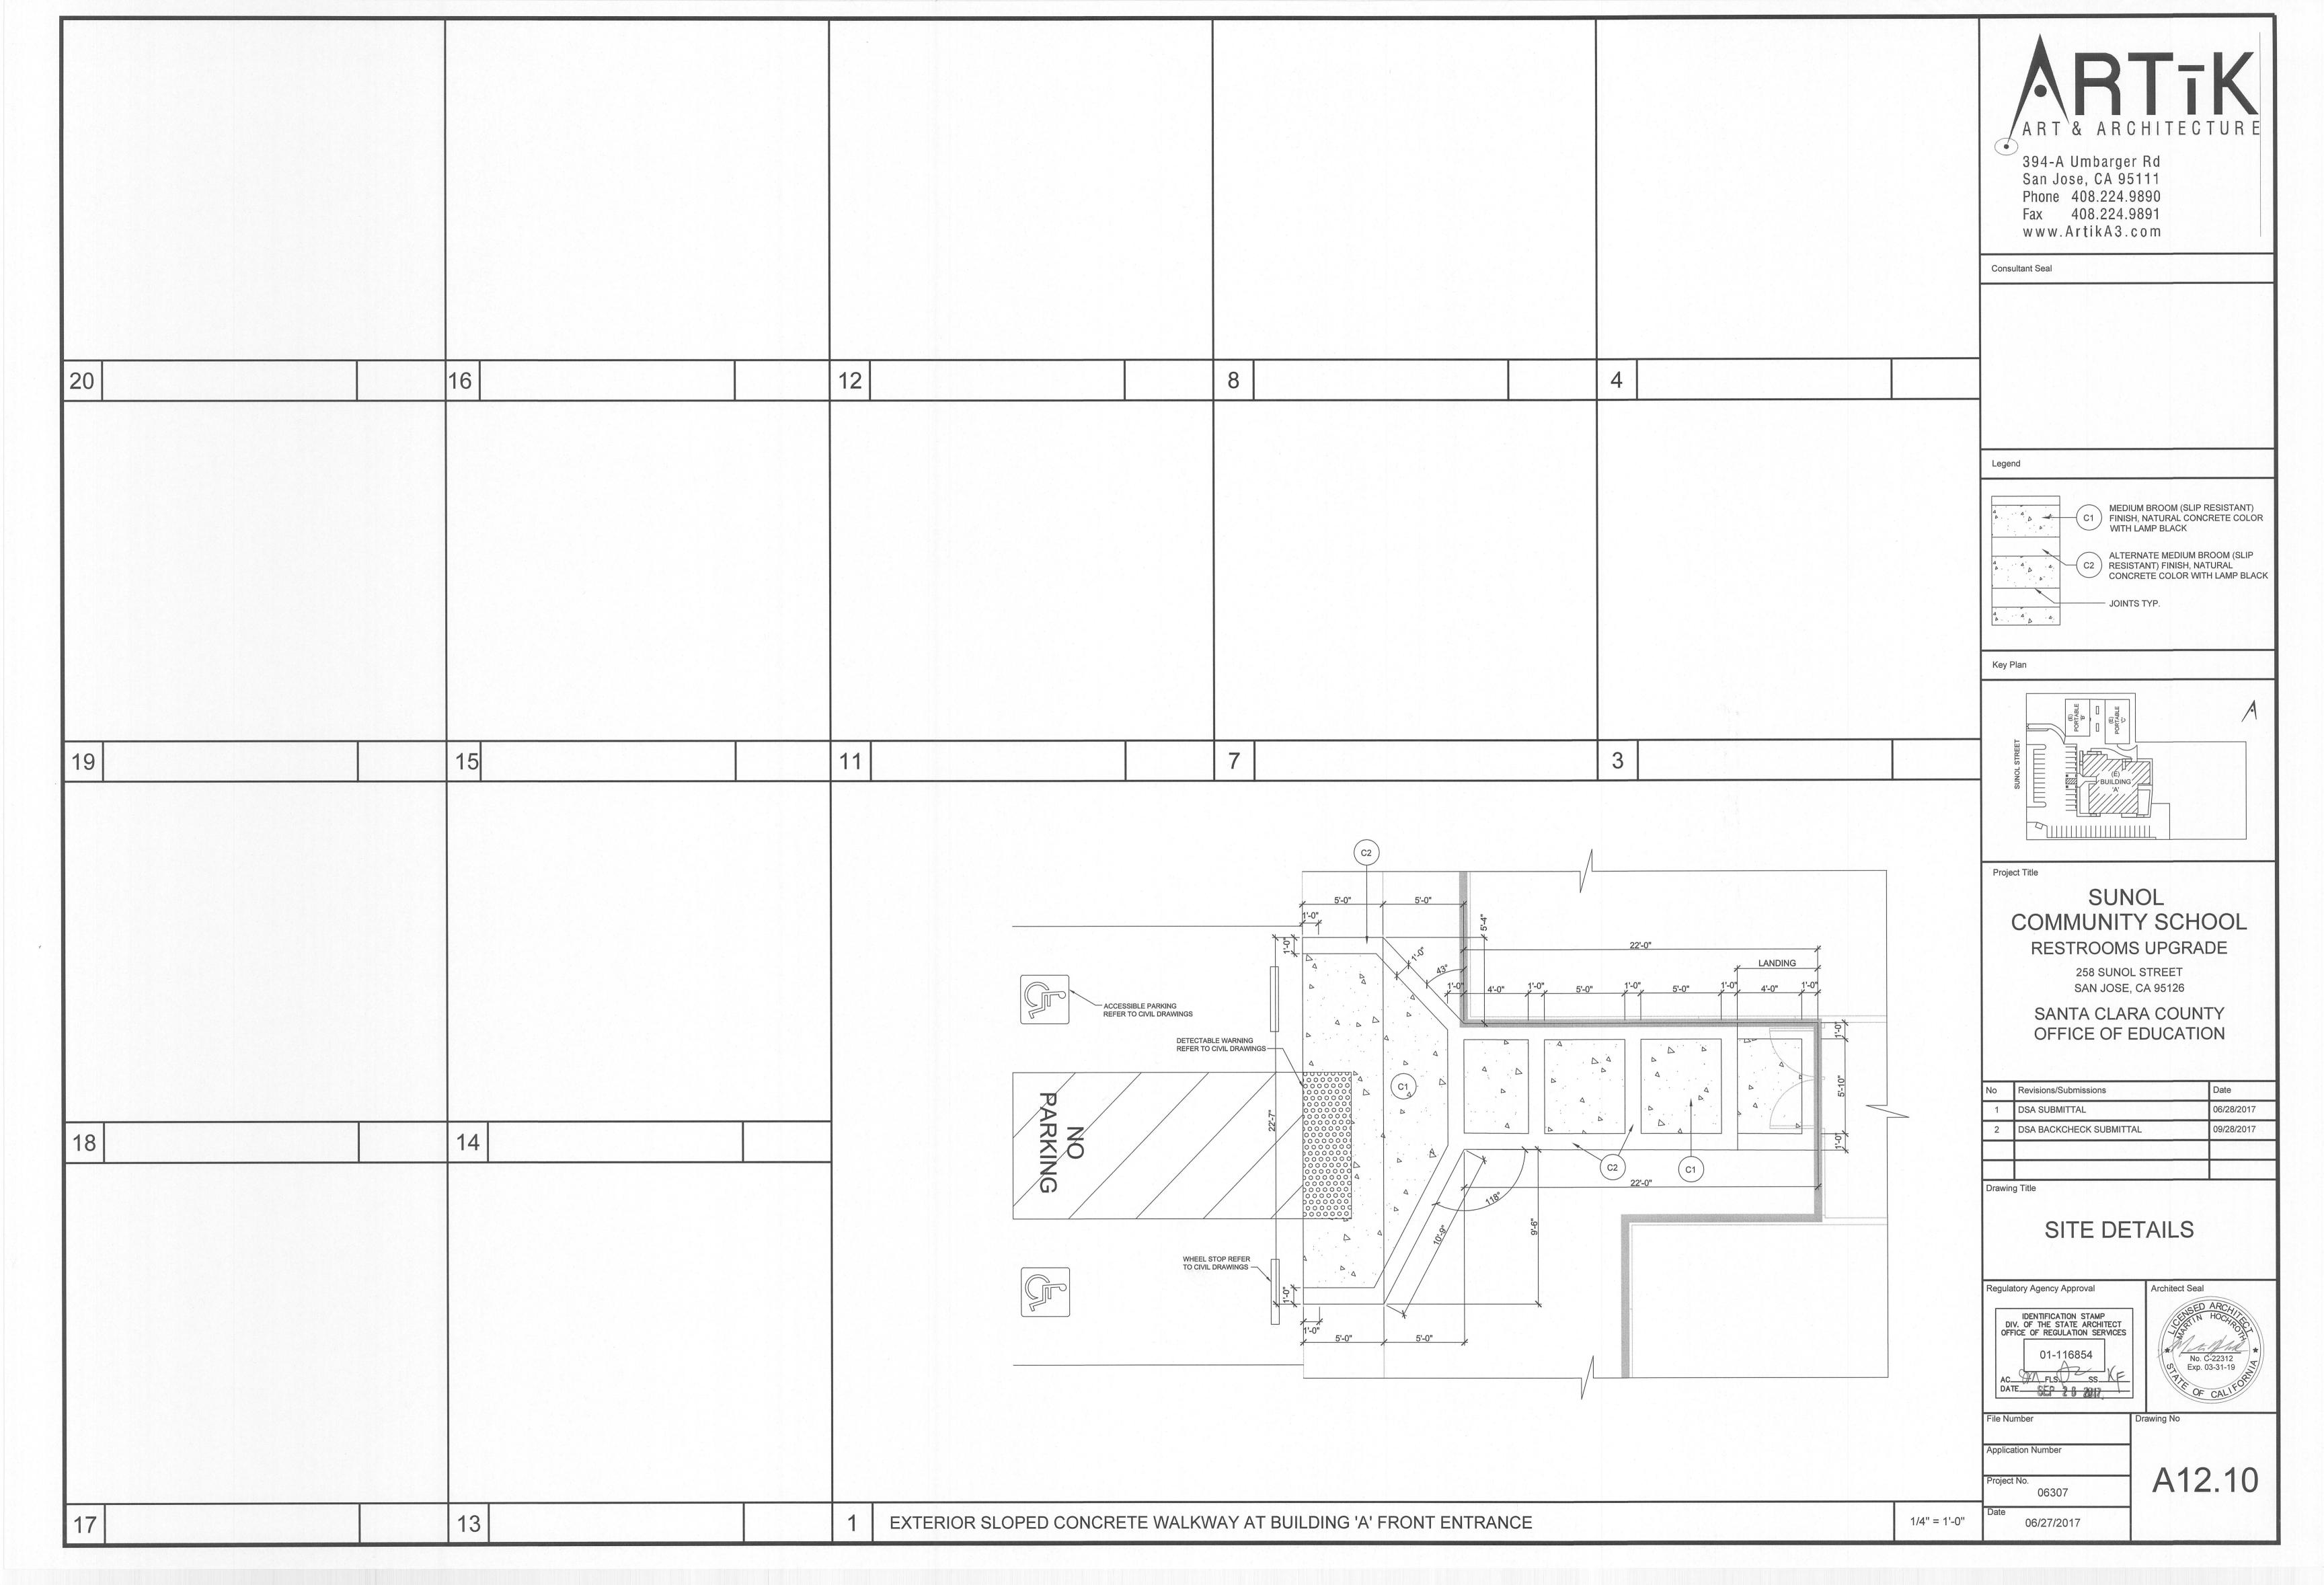- WOOD
- A. FRAMING LUMBER DOUGLAS FIR U.N.O.:
- 1. JOIST AND RAFTERS: NO.1, U.N.O.
- . BEAMS, POST AND HEADERS: NO.1, U.N.O. 3. STUDS, PLATES, BLOCKS, LIGHT FRAMING AND MISC: NO.1, U.N.O. 4. THE MOISTURE CONTENT OF ALL LUMBER 4X OR GREATER SHALL BE VERIFIED BY PROJECT INSPECTOR AT THE TIME OF FRAMING.
- 5. MOISTURE CONTENT SHALL NOT EXCEED 15% FOR WALL STRUCTURAL MEMBERS (i.e. HEADERS, TOP PLATES, SILL AND STUDS). 2X MEMBERS SHALL BE STAMPED "S-DRY".
- C. PROVIDE LATERAL SUPPORT FOR BEAMS, JOIST AND RAFTERS PER CBC SECTION 2308.4.6
- D. FRAMING HARDWARE: ALL LIGHT GAUGE METAL CONNECTORS SHALL BE MANUFACTURED BY "SIMPSON STRONG TIE", OR ALTERNATE APPROVED BY THE STRUCTURAL ENGINEER AND THE DIVISION OF THE STATE ARCHITECT. SIMPSON DESIGNATIONS ARE REFERENCED. INSTALL PER MANUFACTURER'S RECOMMENDATIONS, U.N.O. ON DRAWINGS. FINISH OF CONTACT WITH PRESSURE TREATED WOOD SHALL BE HOT DIPPED ZINC COATED GALVANIZED.
- E. NAILS:
- 1. COMMON WIRE GAGE U.N.O. NAILING TO CONFORM TO CBC TABLE 2304.10.1 U.N.O. 2. MACHINE APPLIED NAILS: MACHINE NAILING OF 5/16" PLYWOOD WILL NOT BE APPROVED. USE OF MACHINE NAILING IS SUBJECT TO A SATISFACTORY JOB SITE DEMONSTRATION FOR EACH PROJECT, THE APPROVAL BY THE STRUCTURAL ENGINEER AND THE DIVISION OF THE STATE ARCHITECT. THE APPROVAL IS SUBJECT TO CONTINUED SATISFACTORY PERFORMANCE. IF NAIL HEADS PENETRATE THE OUTER PLY MORE THAN WOULD BE NORMAL FOR HAND HAMMERED OR IF MINIMUM ALLOWABLE EDGE DISTANCES ARE NOT MAINTAINED, THE PERFORMANCE WILL BE DEEMED UNSATISFACTORY. MACHINE NAILING IS PROHIBITED AT DOUBLE SHEATHED PLYWOOD WALLS OR OTHER APPLICATIONS WHERE THE PRESENCE OF "SHINERS" CAN NOT BE VERIFIED BY VISUAL OBSERVATION. FOR DOUBLE SIDED PLYWOOD SHEAR WALLS. USE HAND NAILING FOR SECOND SIDE OF PLYWOOD.
- 3. GALVANIZED NAILS WHERE THEY OCCUR SHALL BE HOT-DIPPED ZINC COATED.
- F. LAG SCREWS PER ANSI/ASME STANDARD B18.2.1 PROVIDE LEAD HOLE SAME DIAMETER AND DEPTH AS SHANK AND THEN DRILL HOLE 60%-70% OF SHANK DIAMETER FOR THREADED PORTIONS.
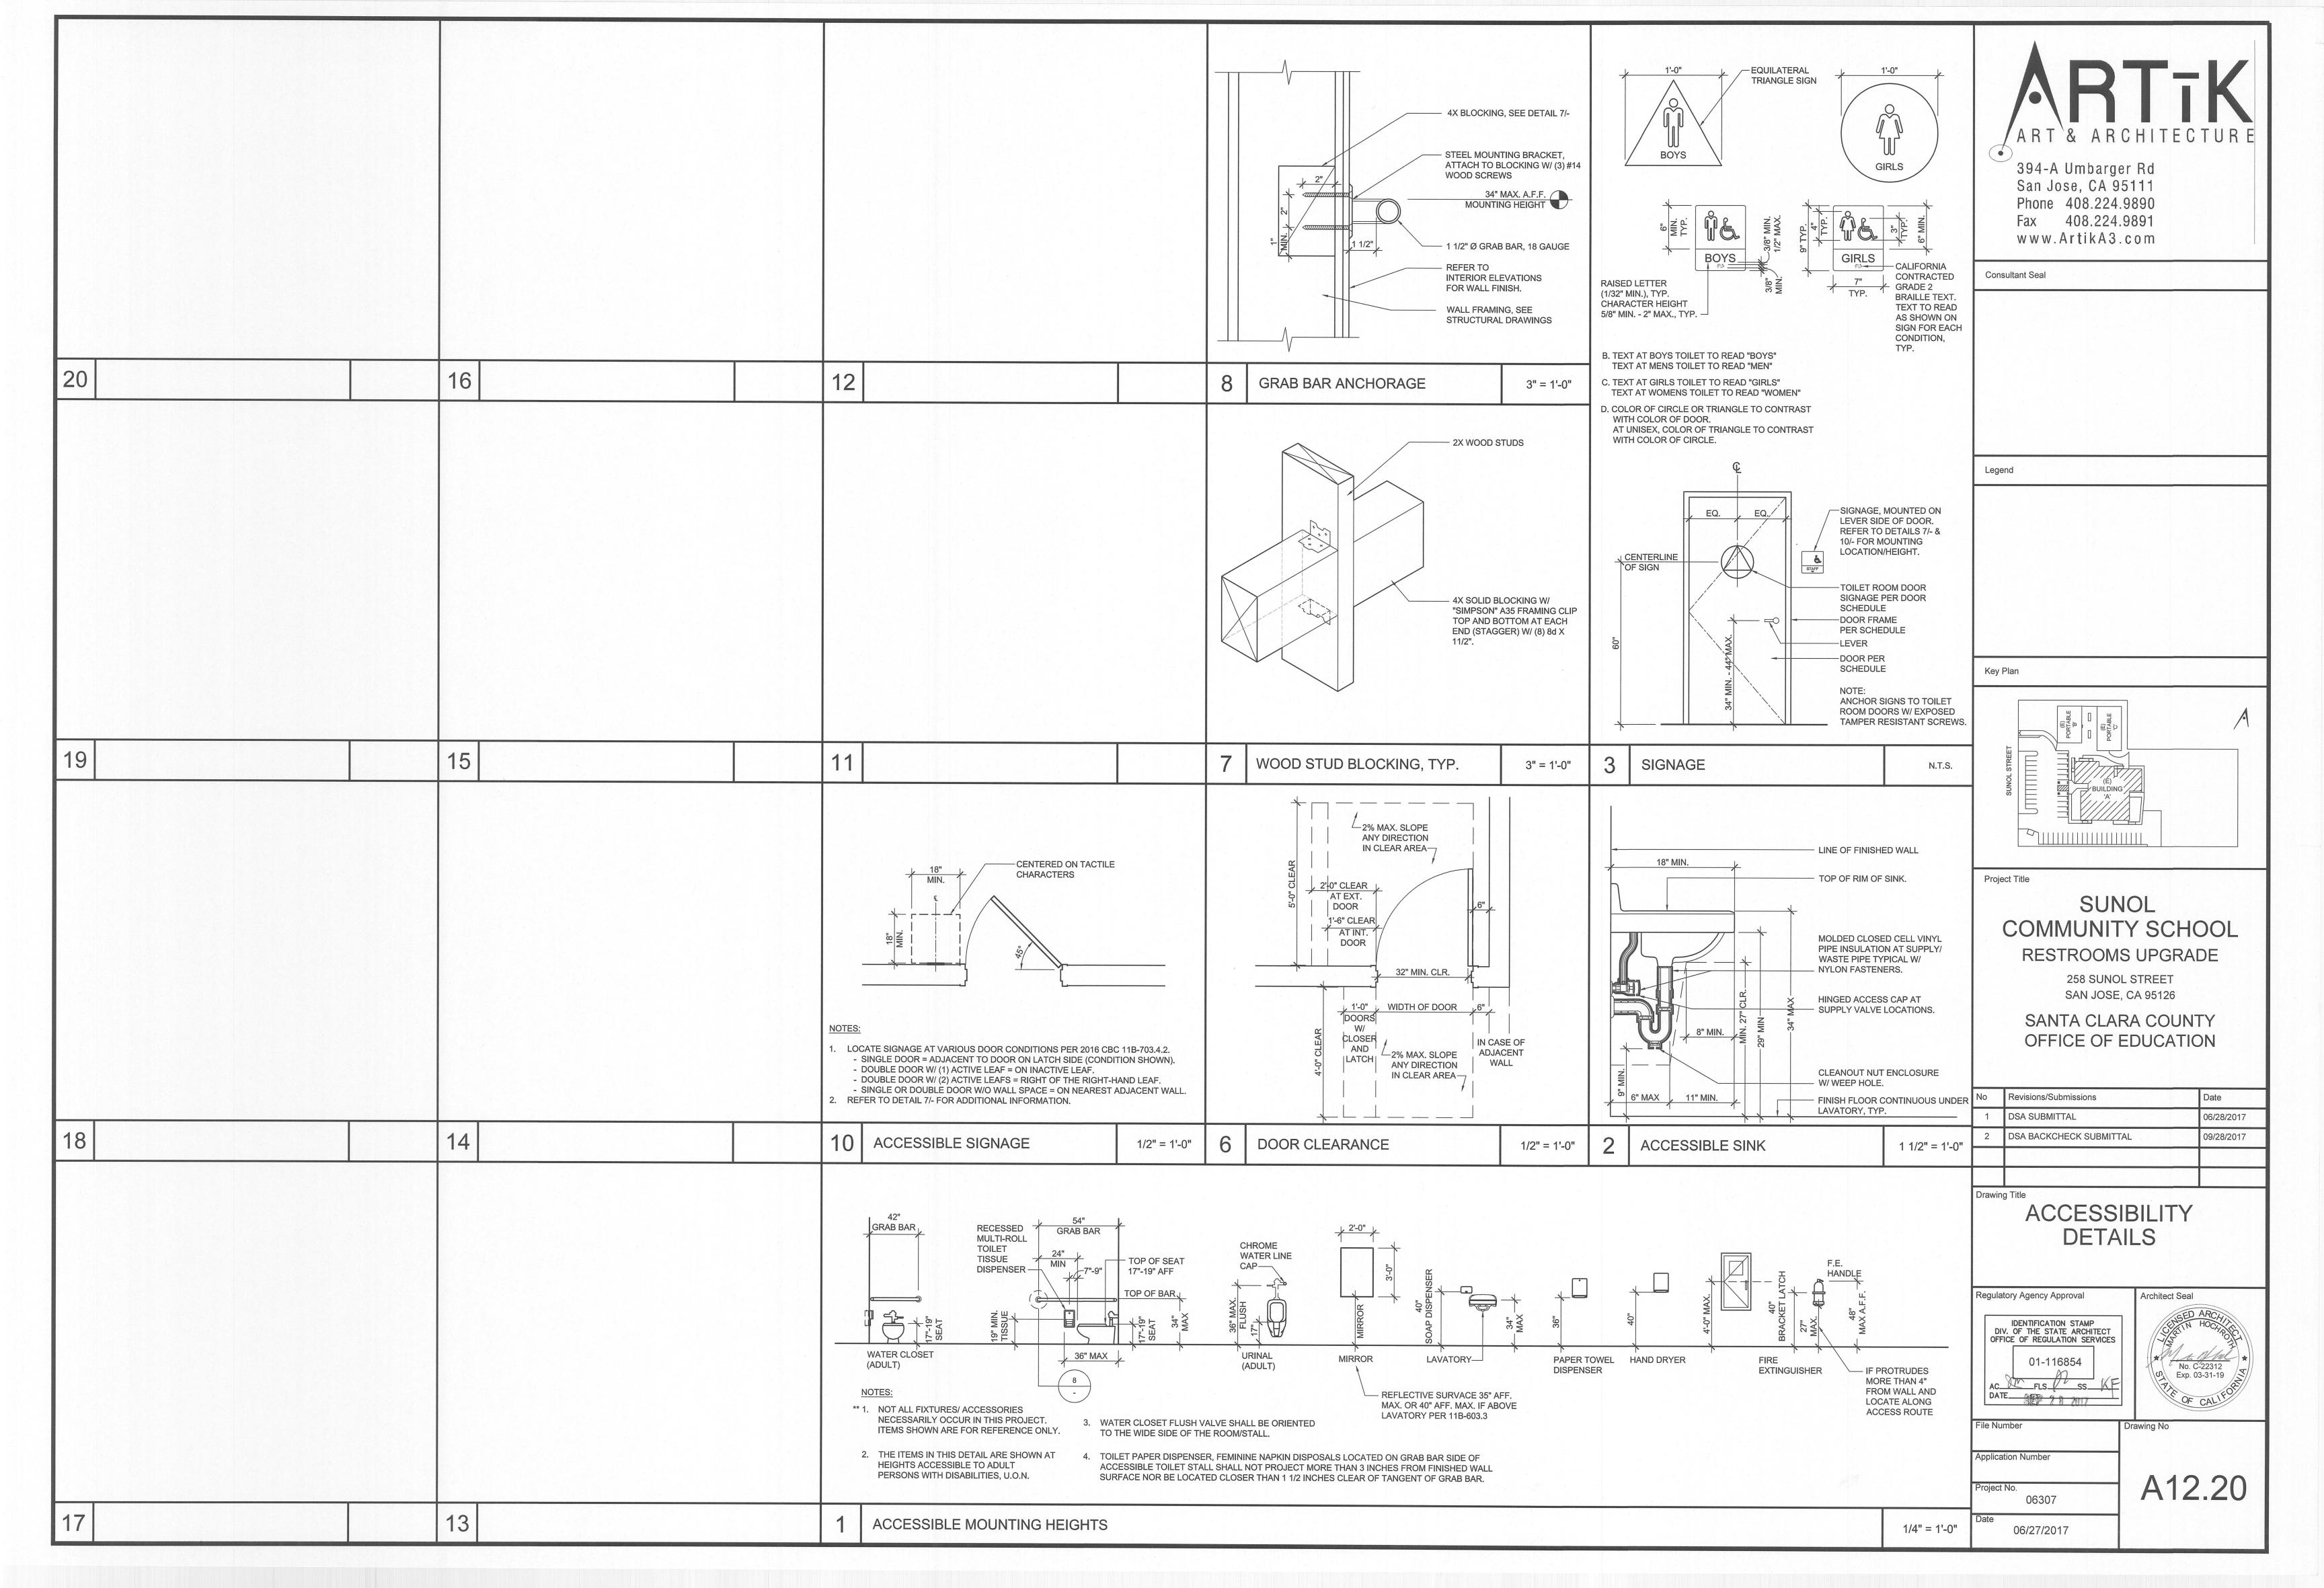
#### EXPANSION ANCHORS (HILTI)

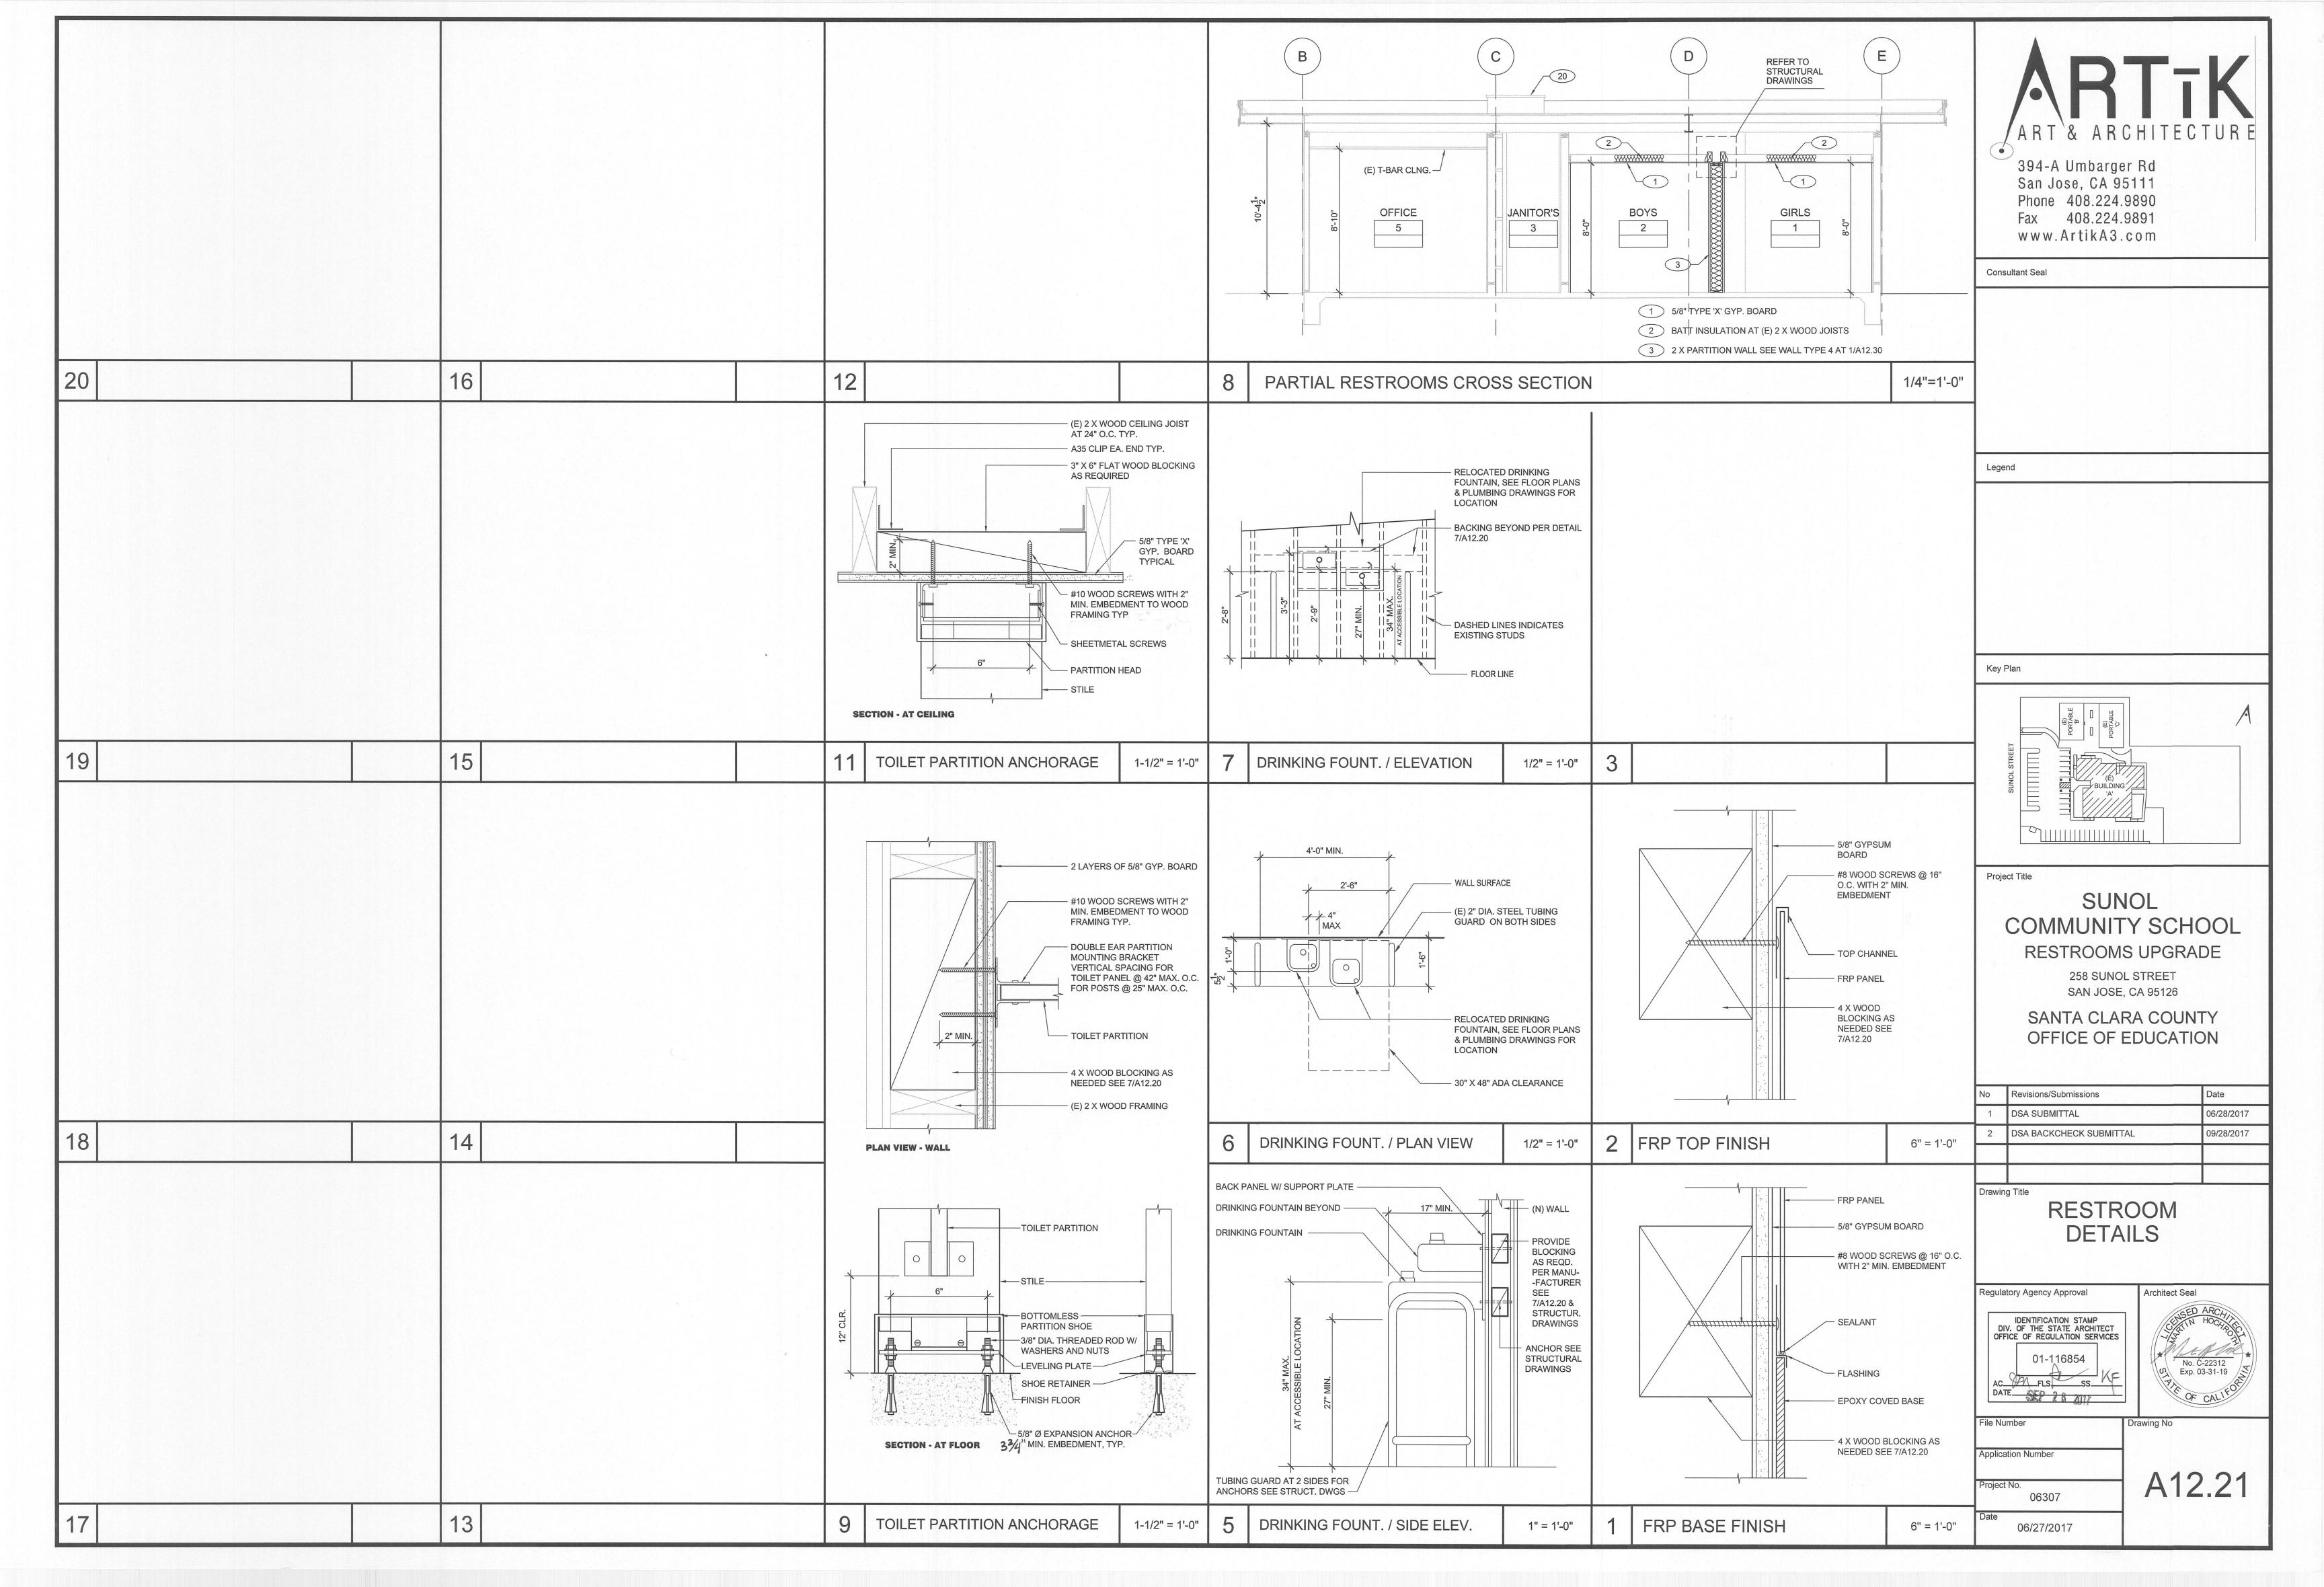- A. EXPANSION ANCHORS SHALL BE HILTI KWIK BOLT TZ CARBON STEEL ANCHOR (ESR-1917) OR EQUIVALENT PRODUCT. ALTERNATIVE PRODUCTS MUST BE SUBMITTED TO E.O.R. FOR SUBSTITUTION PRIOR TO INSTALLATION PER SPECIFICATIONS.
- B. SPECIAL INSPECTION SHALL BE PROVIDED IN ACCORDANCE WITH SECTION 1701 OF THE CBC (1701A FOR DSA PROJECTS).
- C. INSTALLATION: INSTALL THE EXPANSION ANCHORS IN ACCORDANCE WITH THE MANUFACTURES RECOMMENDATIONS FOR THE SPECIFIC ANCHOR.
- D. NOTIFY ARCHITECT IMMEDIATELY IF ELEMENTS WITH EXISTING STRUCTURE PREVENT DRILLING IN THE LOCATIONS SHOWN ON THE DRAWINGS.
- E. WHEN EXPANSION ANCHORS ARE USED FOR SILL PLATE BOLTING, 10% OF THE ANCHORS SHALL BE TENSION TESTED. FOR ALL OTHER STRUCTURAL APPLICATIONS, ALL EXPANSION ANCHORS SHALL BE TENSION TESTED. WHEN EXPANSION ANCHORS ARE USED FOR NON-STRUCTURAL APPLICATIONS, 50% OF ANCHORS SHALL BE TENSION TESTED. IF ANY ANCHOR FAILS TESTING, TEST ALL ANCHORS OF THE SAME TYPE NOT PREVIOUSLY TESTED UNTIL 20 CONSECUTIVE ANCHORS PASS.

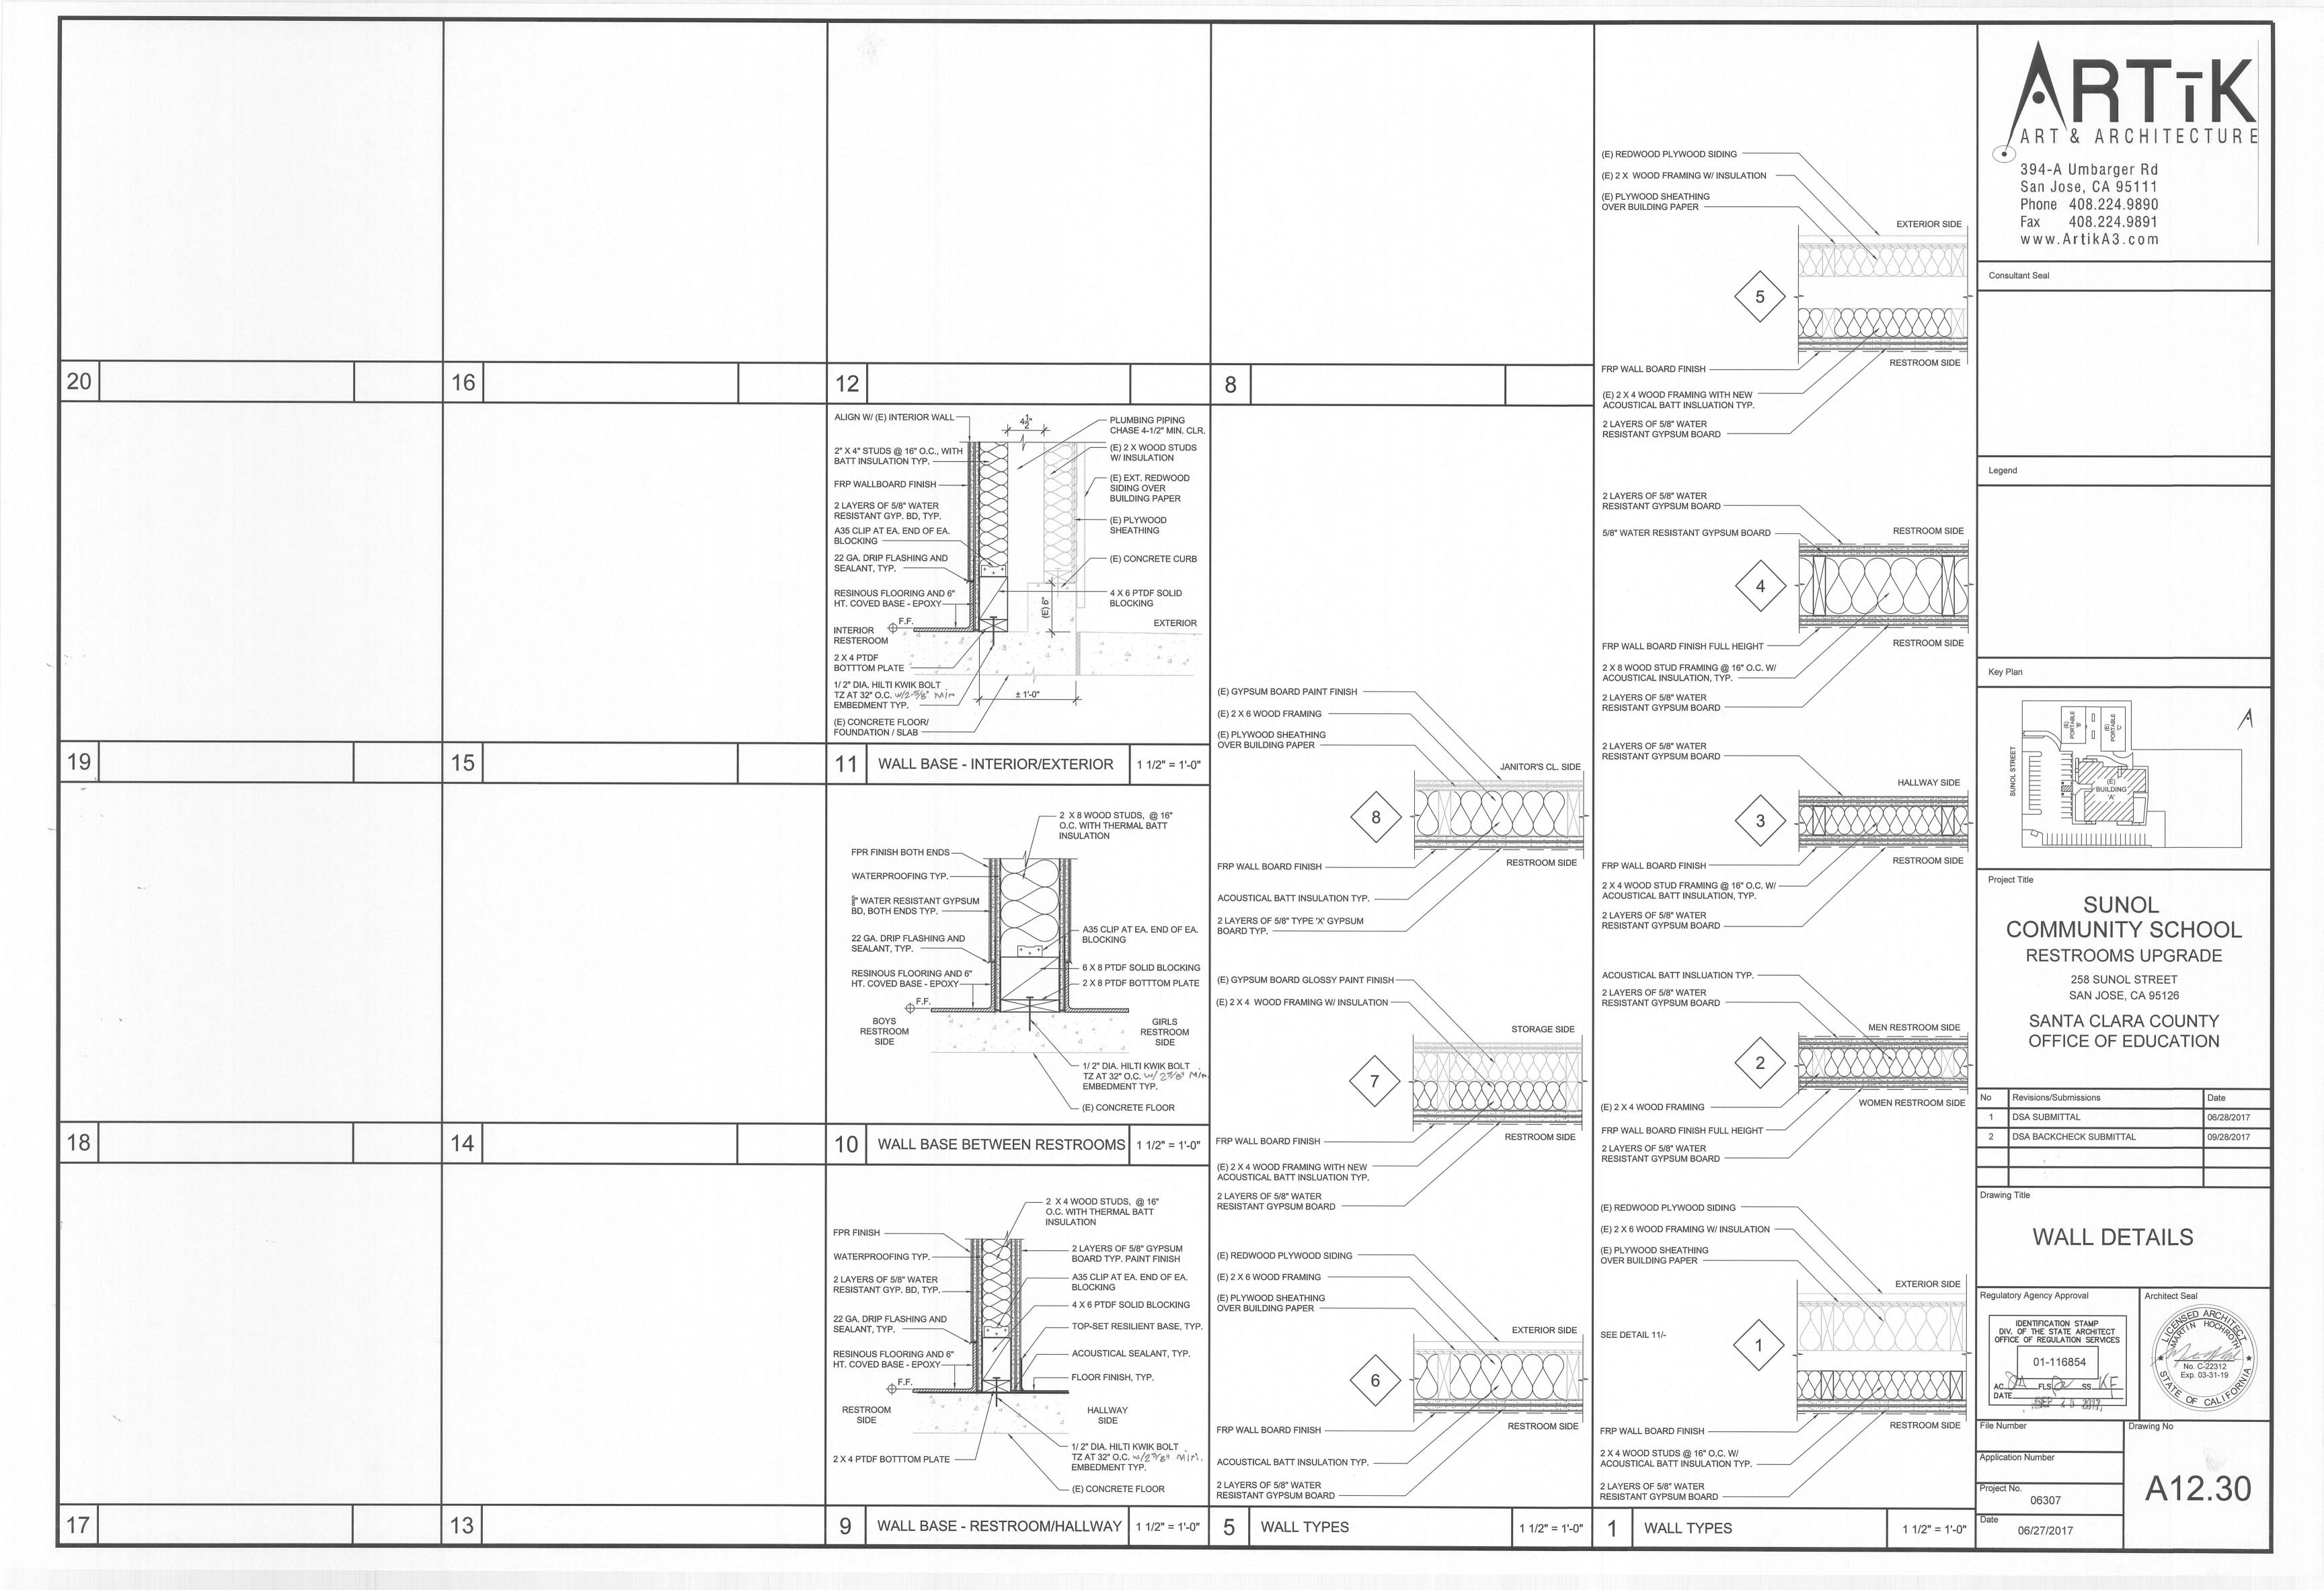MIN. WITH f'c= 2,500 PSI (NORMAL WEIGHT CONCRETE) VERIFY MINIMUM EXISTING CONCRETE STRENGTH IN FIELD.*					
DIA.	MIN. EMBED =MIN. HOLE DEPTH	MIN. EDGE DISTANCE	MIN. SPACING	TENSION** TEST VALUE	TORQUE TEST VALUE
3/8"	2"	2 1/2"	2 1/2"	2,424 LB	25 LB FT
1/2"	2 5/8"	2 3/4"	2 3/4"	4,915 LB	40 LB FT
5/8"	3 3/4"	3 5/8"	3 1/2"	5,015 LB	60 LB FT
3/4"	4"	9 1/2"	5"	5,319 LB	110 LB FT

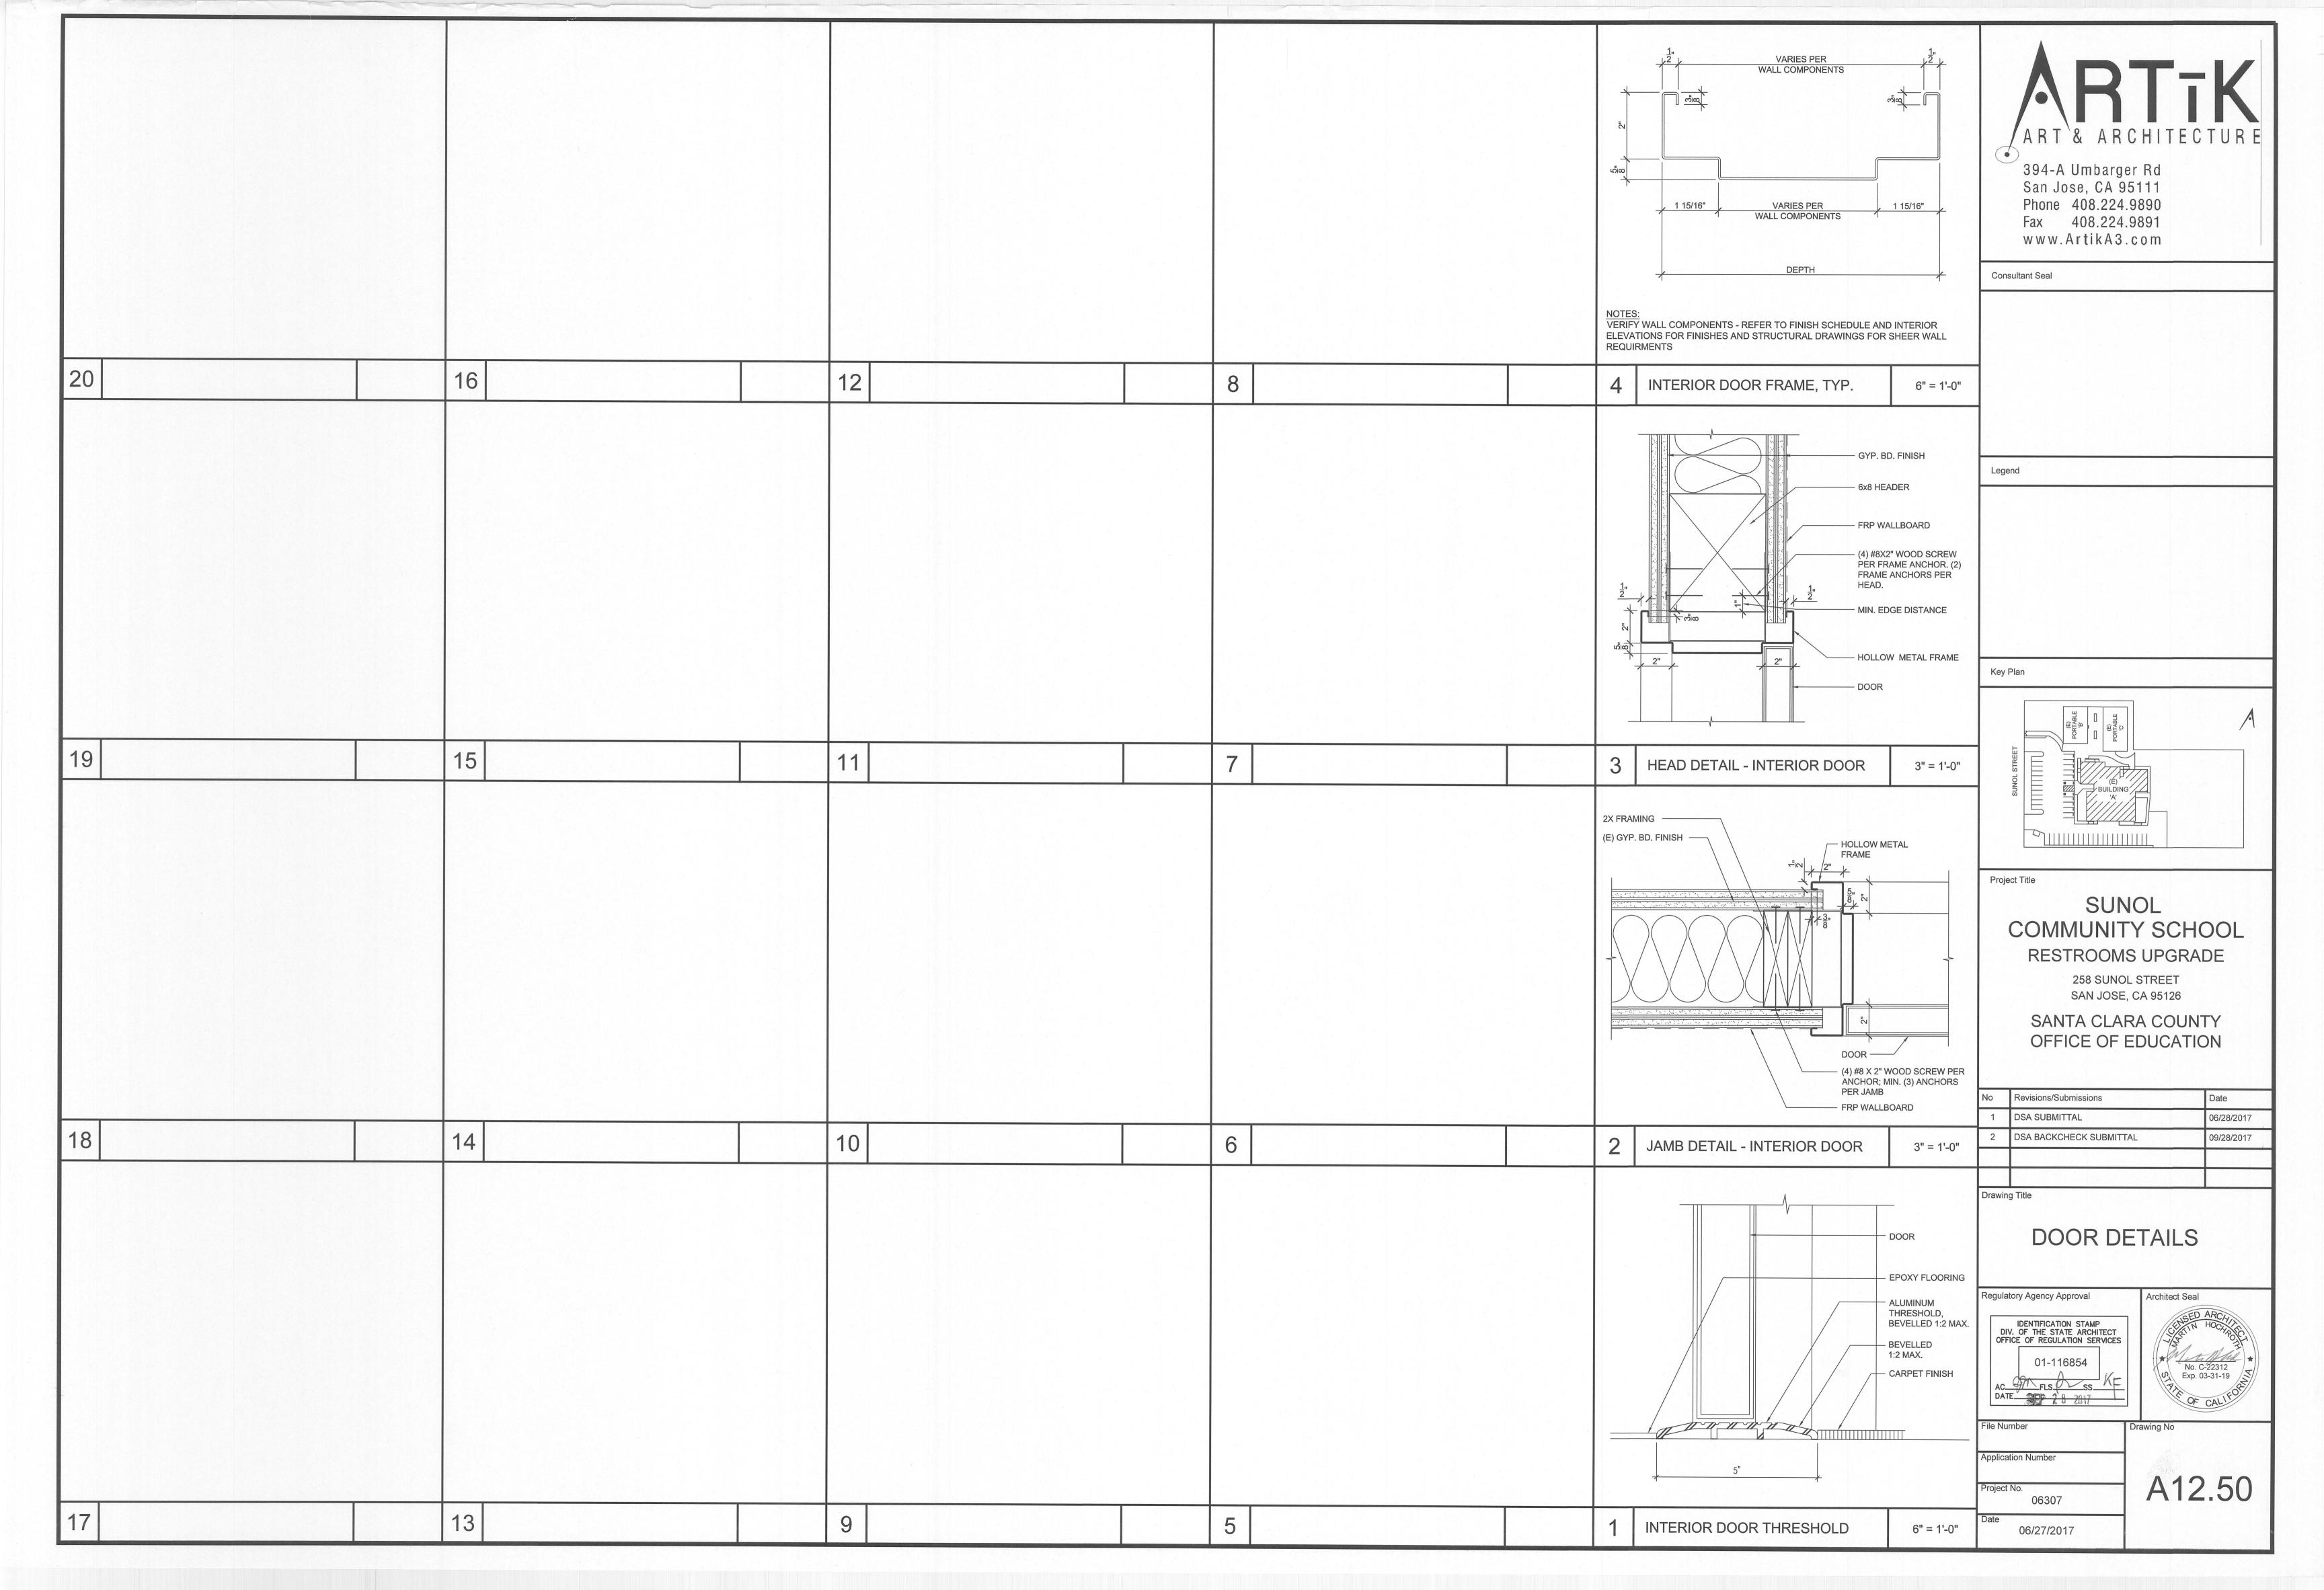- VALUES ARE FOR SINGLE ANCHORS WITH NO EDGE DISTANCE OR SPACING REDUCTION. FOR OTHER CASES, CALCULATIONS ARE REQUIRED FOR REDUCTION
- \*\* TENSION TEST VALUES CORRESPOND WITH 1.5 X CRACKED CONCRETE SEISMIC TENSION LOADS (STRENGTH).

#### PROJECT DESIGN DATA

GOVERNING CODE: 2016 CALIFORNIA BUILDING CODE

#### DESIGN LOADS

CEILING DEAD LOAD = 11 psf CEILING LIVE LOAD = 20 psf

#### SEISMIC DESIGN

SITE CLASS D

 $S_{DC} = D$ Fa = 1.0  $S_{DS} = 1.00$  Fv = 1.5  $S_{D1} = 0.60$ Ss = 1.50 $S_1 = 0.60$ 

 $a_P = 1.0$ ,  $R_P = 2.5$  (ALL OTHER WALLS AND PARTITIONS)

I = 1.25

## PROJECT STRUCTURAL SCOPE

THE SCOPE OF THIS PROJECT APPLIES TO THE BATHROOM REMODEL OF THE EXISTING SCHOOL BUILDING. THE REMODEL DOES NOT INCLUDE ANY MODIFICATIONS TO THE EXISTING BUILDING LATERAL FORCE RESISTING SYSTEM AND THEREFORE ONLY THE BUILDINGS GRAVITY SYSTERM IS APPLICABLE TO THE SCOPE OF WORK. INCLUDED IN THE THE BATHROOM REMODEL IS REMOVING AND REPLACING NON-STRUCTURAL PARTITION WALLS AND CEILING BEAMS.

DRAWING INDEX

GENERAL SPECIFICATIONS, FOUNDATION AND CEILING FRAMING PLAN

TYPICAL WALL FRAMING DETAILS S8.20 WOOD DETAILS

**ABBREVIATIONS**  AT JT. JOIST A.B. ANCHOR BOLT KIP (1,000 LBS.) A.C.I. AMERICAN CONCRETE INSTITUTE K/FT..K/' KIP PER FOOT A.I.S.C. AMERICAN INSTITUTE OF STEEL CONSTRUCTION LIVE LOAD ALT. ALTERNATE MACHINE BOLT ARCH. ARCHITECTURAL MID-DEPTH A.S.T.M. AMERICAN STANDARD FOR TESTING AND MATERIALS MATERIAL A.W.S. AMERICAN WELDING SOCIETY MAX. MAXIMUM (В) ВОТТОМ MECH. **MECHANICAL** MANUFACTURER MFR. BLDG. BUILDING MINIMUM C.G.S. CENTROID OF TENDON C.I.P. CAST-IN-PLACE CONCRETE MISCELLANEOUS C.J. CONSTRUCTION JOINT N.A. NEUTRAL AXIS NUMBER NO., # CENTERLINE NOT TO SCALE CLG. CEILING O.C. ON CENTER CLR. CLEAR OPPOSITE HAND C.M.U. CONCRETE MASONRY UNIT OUTSIDE FACE COL. COLUMN O.W.J. OPEN WEB JOIST CONC. CONCRETE O.W.S.J. OPEN WEB STEEL JOIST CONT. CONTINUOUS PROPERTY LINE, PLATE CTR. CENTER POUND PER SQUARE P.S.F. CU FT. CUBIC FOOT FOOT POUND PER SQUARE INCH P.S.I. CU. IN. CUBIC INCH POST-TENSIONING CU. YD. CUBIC YARD RADIUS

RCJ

R.D.

REF.

BAR DIAMETER DBL. DOUBLE DET. DETAIL DIA. Ø DIAMETER DIAG. DIAGONAL DIMENSION D.L. DEAD LOAD

DN. DOWN DWG.(S) DRAWING(S)

EA. EACH E.F. EACH FACE **ELEVATION** EL. ELEV. ELEVATOR EQ. EQUAL(LY) E.S. EACH SIDE EACH WAY F.D. FLOOR DRAIN FDN. FOUNDATION

FINISH FLOOR F.F. FLR. FTG. FOOTING

G.B. GRADE BEAM HORIZONTAL HIP TRUSS INCH(ES) INSIDE FACE INFO. INFORMATION

SEAONC STRUCTURAL ENGINEERS ASSOCIATION OF NORTHERN CALIFORNIA SECTION SIM. SIMILAR SLAB JOINT S.J. S.O.G. SLAB ON GRADE SPECS. **SPECIFICATIONS** SQ. SQUARE STD. STANDARD STR. STRIAGHT SYM. SYMMETRICAL TOP (T&B) TOP & BOTTOM T.S. STRUCTURAL TUBE

ROUGHEN CONTROL JOINT

REINFORCE(D)/REINFORCING

SEE ARCHITECTURAL DRAWINGS

ROOF DRAIN

REFERENCE

REQUIRED

**TYPICAL** 

U.N.O. UNLESS NOTED OTHERWISE VERT. VERTICAL VALLEY TRUSS V.T. WITH WALL JOINT WATERPROOFING W.W.F. WELDED WIRE FABIRC

SYMBOLS

#### FOUNDATION PLAN

DENOTES (N) TYPICAL WOOD NON-STRUCTURAL PARITITION WALL DENOTES (E) WOOD WALL DENOTES (E) CONTINUOUS WALL FOOTING TYPICAL

DENOTES (E) COLUMN TYPICAL

DENOTES (E) ISOLATED SPREAD FOOTING


DENOTES (N) WOOD COLUMN

#### ROOF PLAN


DENOTES (N) TYPICAL WOOD NON-STRUCTURAL PARITITION WALL DENOTES (E) WOOD WALL BELOW ROOF FRAMING LEVEL DENOTES (E) CEILING JOIST TYP. DENOTES (N) WOOD STRUCTURAL MEMBER TYP.

DENOTES (N) HANGER TYP.

DENOTES (N) WOOD POST BELOW

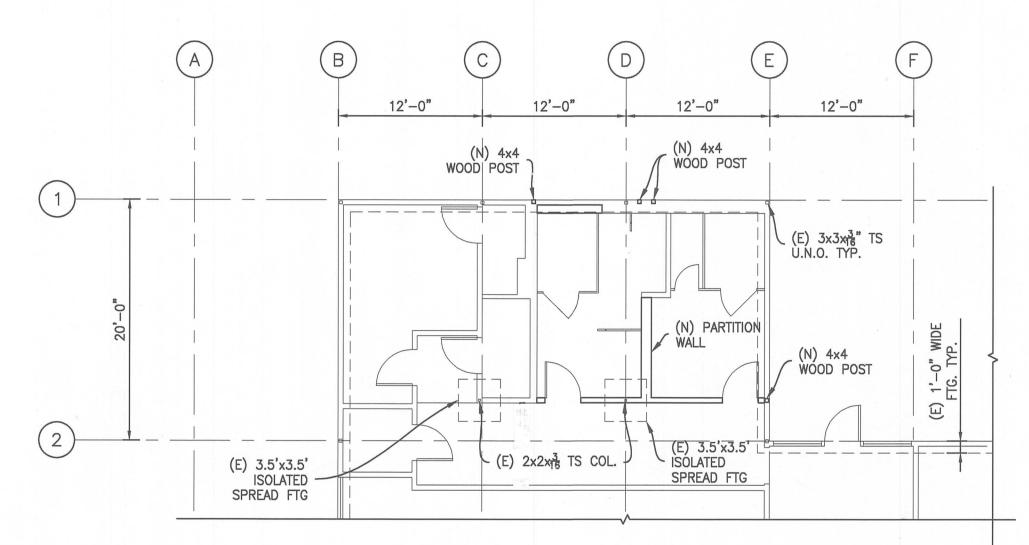



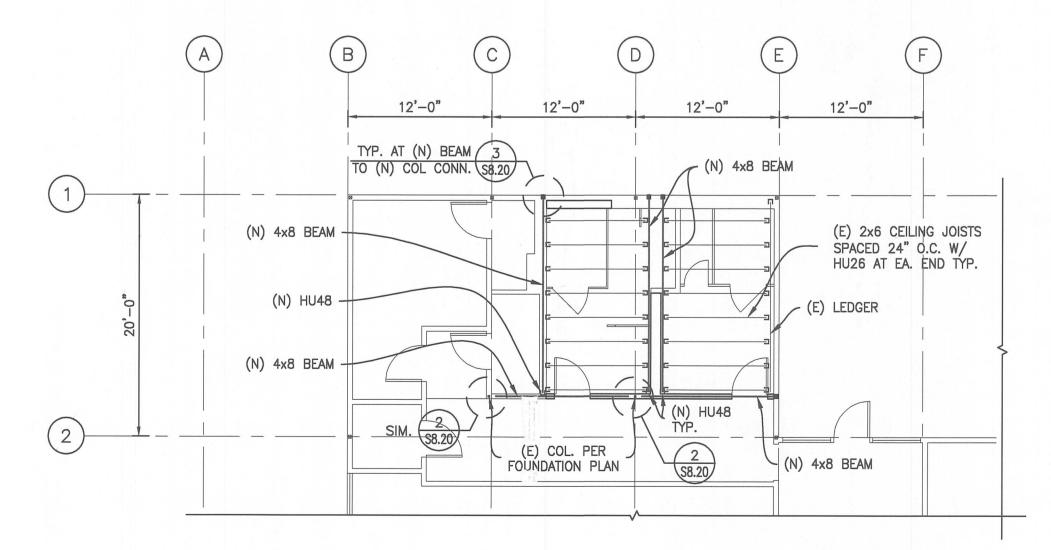

CEILING FRAMING PLAN





394-A Umbarger Rd San Jose, CA 95111 Phone 408.224.9890 Fax 408.224.9891 www.ArtikA3.com

Consultant Seal


# STRUCTURAL ENGINEERS

1996 Tarob Court Milpitas, CA 95035



Legend

Key Plan

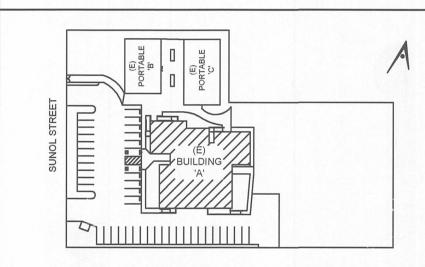

Project Title

# SUNOL COMMUNITY SCHOOL **RESTROOMS UPGRADE**

258 SUNOL STREET SAN JOSE, CA 95126


SANTA CLARA COUNTY OFFICE OF EDUCATION

1         DSA SUBMITTAL         06/28/           2         DSA BACKCHECK SUBMITTAL         09/28/
2 DSA BACKCHECK SLIBMITTAL 00/28/
2 DSA BACKCHECK GODIVITTAL 09/20/

Drawing Title

GENERAL SPECIFICATIONS, FOUNDATION AND CEILING FRAMING PLANS


Regulatory Agency Approval IDENTIFICATION STAMP DIV. OF THE STATE ARCHITECT OFFICE OF REGULATION SERVICES AC\_\_\_FLS\_\_\_SS\_\_\_

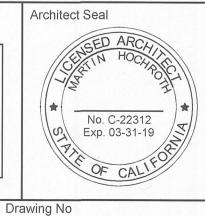


File Number

Application Number Project No.


S<sub>1.0</sub>

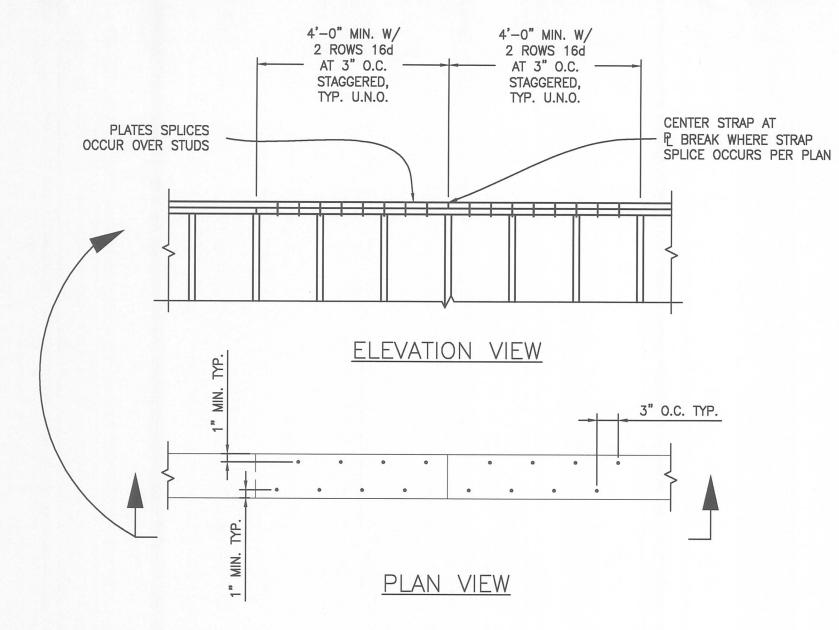

DETAIL - TOP PLATE SPLICE

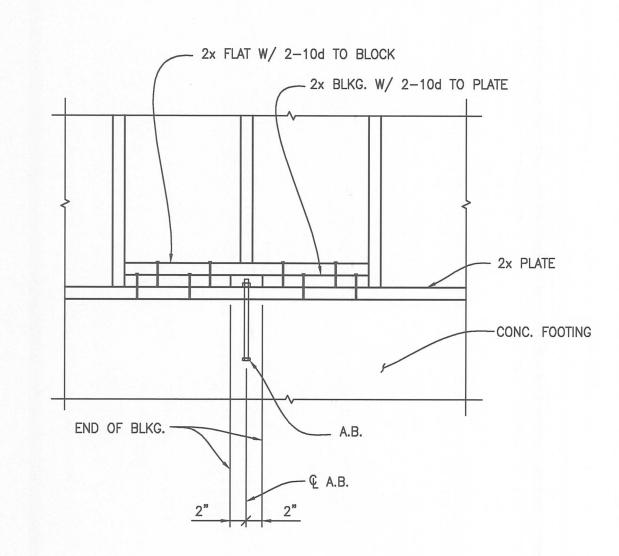


DETAIL - FRAMING WHERE STUD CONFLICTS W/ A.B.

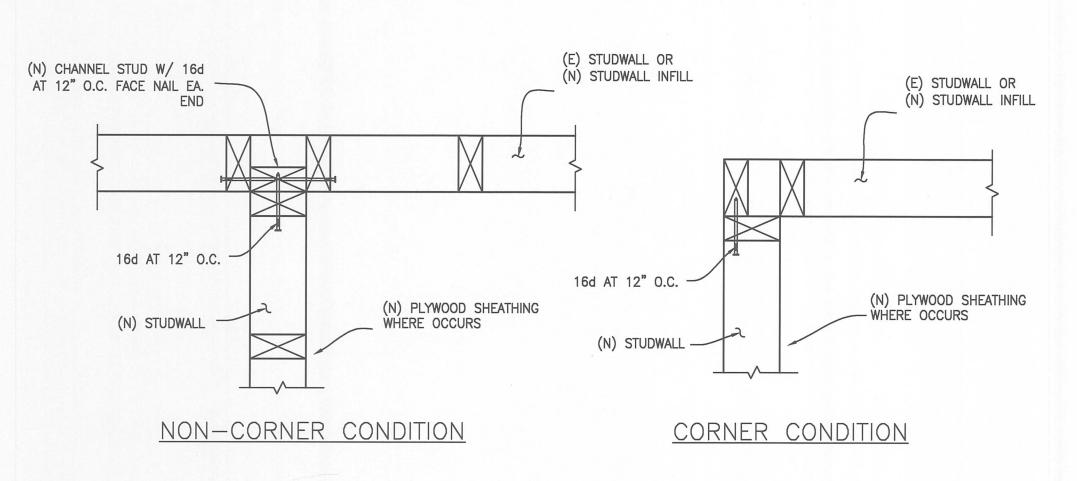

9 DETAIL - (N) WALL PERP. TO (E) OR (N) WALL

S8.10 1" = 1'-0"

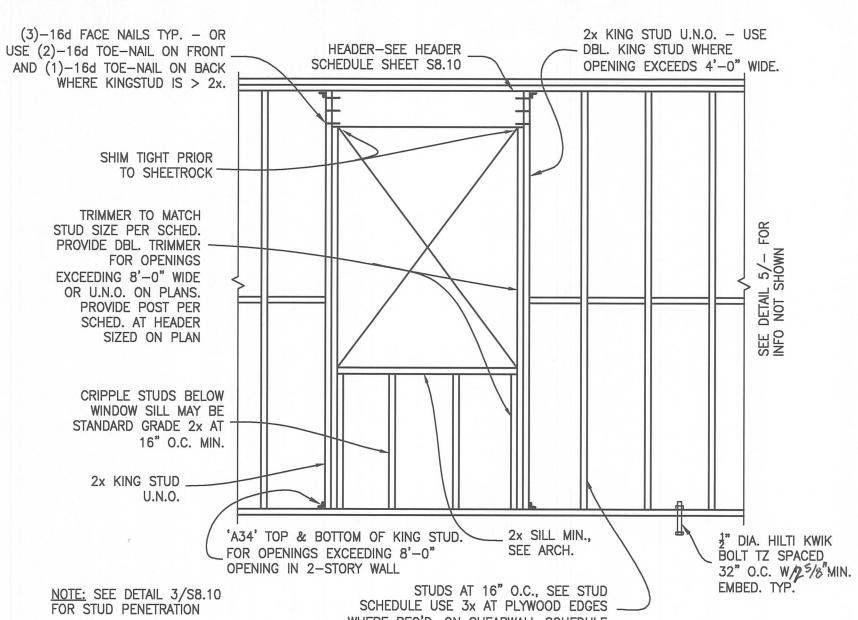


WHERE REQ'D. ON SHEARWALL SCHEDULE TYP. WALL FRAMING

TYPICAL NAILING SCHEDULE CONNECTION NAILING JOIST OR RAFTER TO TOP PLATE 3-8d TOENAILS TOP PLATE TO STUD, END NAIL 2-16d 4-8d, TOENAIL OR STUD TO 2x SOLE PLATE 2-16d, END NAIL STUD TO 3x SOLE PLATE 4-8d, TOENAIL OR 2-20d (PRE-DRILL), END NAIL DOUBLE STUDS, FACE NAIL 16d AT 24" O.C. BLOCKING BETWEEN JOISTS OR 3-8dRAFTERS TO TOP PLATE, TOENAIL RIM JOIST TO TOP PLATE, TOENAIL 8d AT 6" O.C. CONTINUOUS HEADER TO STUD, 4-8d **TOENAIL** NAILING REQUIREMENTS SHOWN HERE ARE SUPERCEDED WHERE REQUIREMENTS OF THE STRUCTURAL DRAWINGS INDICATE DIFFERENT ATTACHMENT.

THE REQUIREMENTS ABOVE ARE DERIVED FROM THE 2016 CALIFORNIA BUILDING CODE CHAPTER 23, TABLE 2304.10.1. ATTACHMENTS NOT INDICATED OF THE STRUCTURAL DRAWINGS SHALL BE IN CONFORMANCE TO THESE MINIMUM REQUIREMENTS.

DETAIL - NAILING SCHEDULE

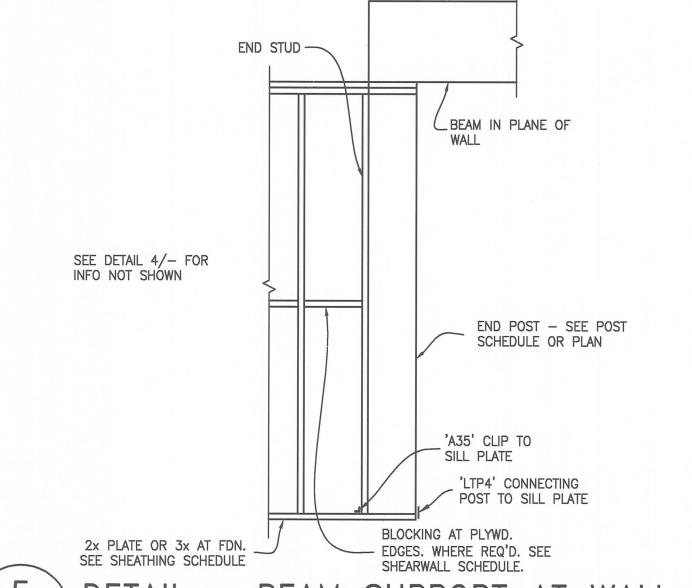


BEAM SUPPORT AT WALL 1/2" = 1'-0"

HE	ADER	SCHEDULE	1
OPENING SIZE		MINIMUM HEADI	ER UNO ON PLAN
OFENING SIZE		2x4 STUDWALL	2x6 STUDWALL
0 - 3'		4×6	6x6
3.1' - 6'		4x8	6x6
6.1' - 8'		4×10	6x8
8.1' - 11'		4x12	6x10
	2x6 STUDWALL	HEADER CONSTRUCTION.	

VULIAIL - HEADER SCHEDULE

	STUD SCHEDULE
MAX. NOM. PLATE HT.	INTERIOR NON-BEARING WALLS
8'-0"	2x4 AT 16" O.C.

DETAIL - STUD SCHEDULE NON-STRUCTURAL PARTITION WALLS

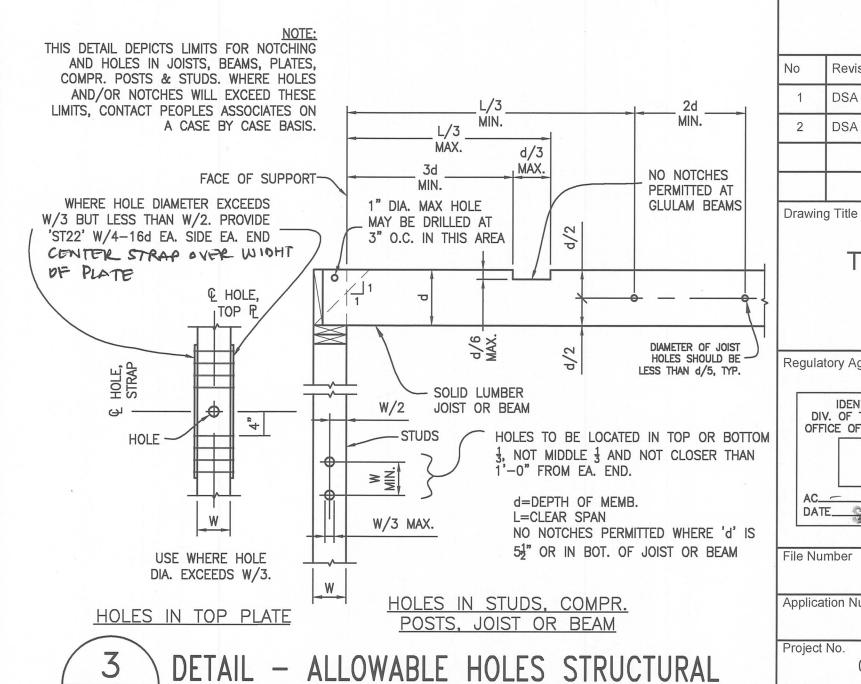

SAWN LUMBER MEMBERS



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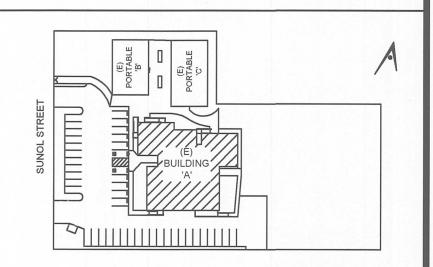
# PEOPLES ASSOCIATES

1996 Tarob Court Milpitas, CA 95035



Legend

Key Plan



Project Title


## SUNOL **COMMUNITY SCHOOL RESTROOMS UPGRADE**

258 SUNOL STREET SAN JOSE, CA 95126

SANTA CLARA COUNTY OFFICE OF EDUCATION


No	Revisions/Submissions	Date
1	DSA SUBMITTAL	06/28/2017
2	DSA BACKCHECK SUBMITTAL	09/28/2017

TYPICAL WALL FRAMING **DETAILS** 

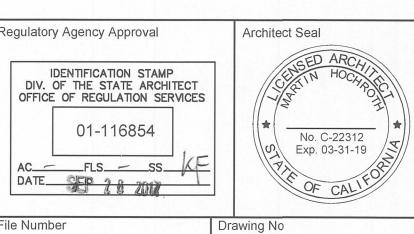


File Number Application Number

S8.10

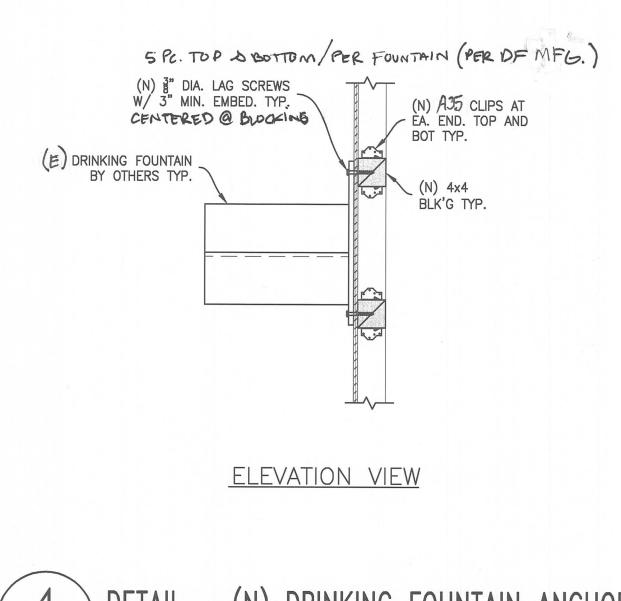




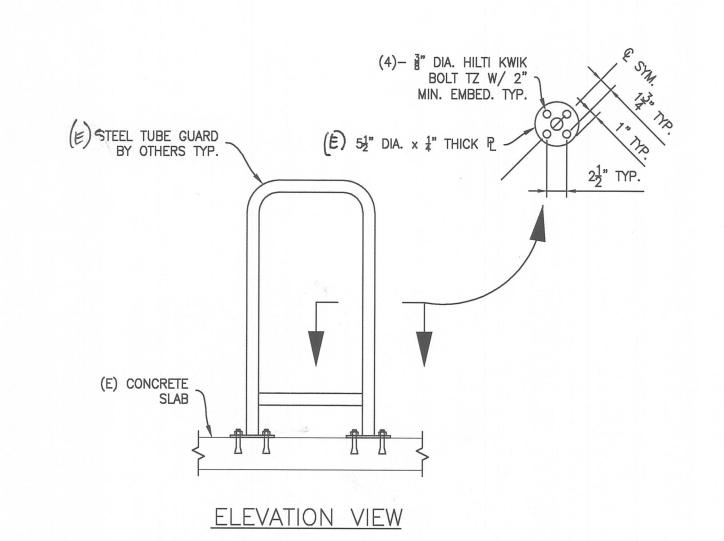


5 DETAIL - (N) TUBING GUARD ANCHORAGE

S8.20 1" = 1'-0"

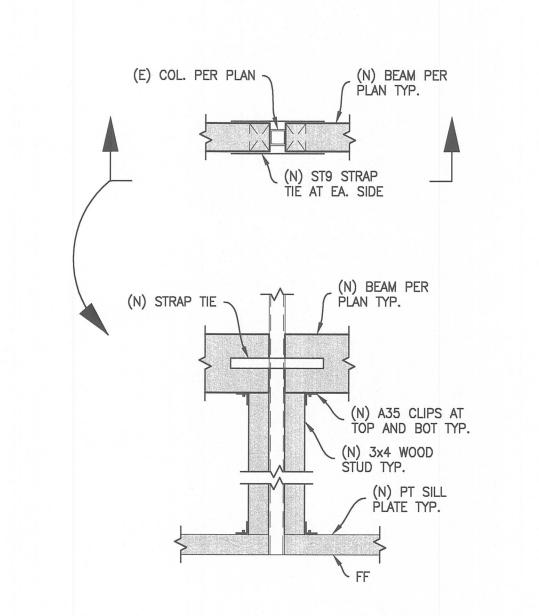

2 DETAIL - (N) WOOD BEAM TO (E) STEEL COL.

S8.20 1" = 1'-0"

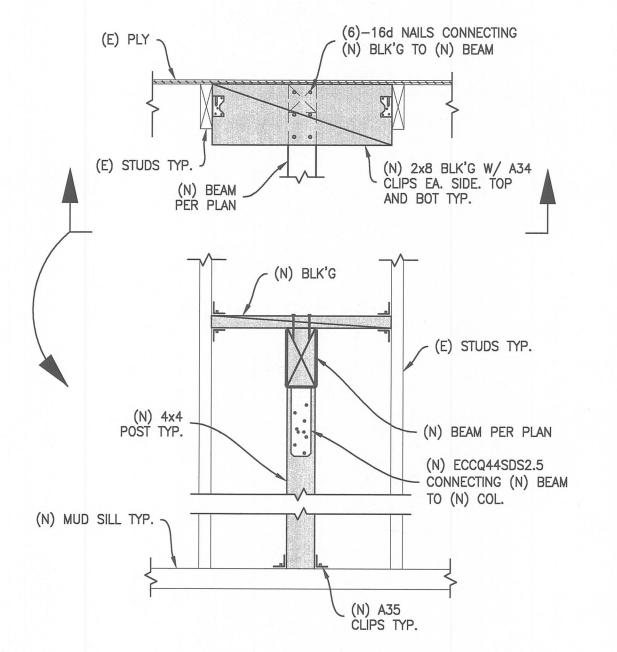



Consultant Seal

\_ 'DTC' TRUSS CLIP AT EA. RAFTER

NON BEARING STUDWALLSEE ARCH DWGS

NON BEARING STUDWALL \_ - SEE ARCH DWGS

'DTC' TRUSS CLIP . AT EA. BLOCK


FULL DEPTH BLKG. AT 24" O.C. MAX.

PERPENDICULAR TO RAFTER

PARALLEL TO RAFTER



Legend

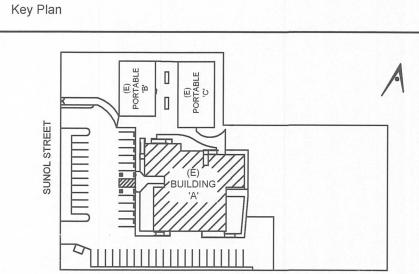

Project Title

# SUNOL COMMUNITY SCHOOL RESTROOMS UPGRADE

258 SUNOL STREET SAN JOSE, CA 95126

SANTA CLARA COUNTY OFFICE OF EDUCATION

No	Revisions/Submissions	Date
1	DSA SUBMITTAL	06/28/2017
2	DSA BACKCHECK SUBMITTAL	09/28/2017

WOOD DETAILS

Regulatory Agency Approval Architect Seal IDENTIFICATION STAMP
DIV. OF THE STATE ARCHITECT
OFFICE OF REGULATION SERVICES 01-116854 No. C-22312 Exp. 03-31-19 AC\_\_\_FLS\_\_\_SS\_\_KF DATE\_\_SCP\_\_2\_8\_2017 Drawing No

File Number Application Number Project No.

06307

06/27/2017

S8.20

#### **GENERAL NOTES**

BEFORE COMMENCEMENT OF WORK, THE CONTRACTOR SHALL VERIFY THE EXACT LOCATIONS, ELEVATIONS AND CHARACTERISTICS OF ALL UTILITIES AND PIPING, AND SHALL IMMEDIATELY NOTIFY THE ARCHITECT OF ANY DISCREPANCIES.

- EXACT LOCATIONS AND MOUNTING HEIGHTS OF PLUMBING FIXTURES SHALL BE OBTAINED FROM THE ARCHITECTURAL DRAWINGS.
- SEE ARCHITECTURAL DRAWINGS FOR ADA FIXTURE LOCATIONS AND MOUNTING HEIGHTS. (INSULATE ALL EXPOSED HOT AND COLD WATER AND DRAIN
- PIPING BELOW ADA LAVATORIES AND SINKS AND OFFSET P-TRAP AGAINST WALL. ALSO, ALL FLUSH VALVES SHALL BE TO WIDE SIDE OF STALL.)
- THE CONTRACTOR SHALL MAKE ALL ARRANGEMENTS WITH UTILITY COMPANIES FOR SERVICE IN THE NAME OF THE OWNER AND SHALL PAY ALL MATERIAL AND LABOR COSTS INCIDENTAL TO AN OPERABLE UTILITY SERVICE AS REQUIRED BY THE DESIGNATED GOVERNING AUTHORITIES OF THE
- ALL PLUMBING WORK SHALL BE INSTALLED SO AS TO AVOID INTERFERENCE WITH ELECTRICAL AND MECHANICAL EQUIPMENT AND STRUCTURAL

TRAPS FOR ALL LAVATORIES AND SINKS SHALL TRAP STRAIGHT BACK TO WALL WITH ALL REQUIRED OFFSETS HAPPENING WITHIN THE WALL.

- THE CONTRACTOR SHALL COORDINATE THE LOCATION OF ALL CEILING ACCESS PANELS WITH THE ARCHITECTURAL REFLECTED CEILING PLANS AND THE ELEC. LIGHTING LAYOUT.
- THE PLUMBING CONTRACTOR SHALL PROVIDE THE WATER, SEWER AND STORM DRAIN SYSTEMS TO A POINT OF CONNECTION SHOWN ON FLOOR
- PLANS AND SHALL MEET THE INVERT ELEVATION AS FIELD VERIFIED WHILE MAINTAINING REQUIRED PIPE GRADE. ANY ALTERATIONS TO A STRUCTURAL MEMBER, SUCH AS CUTTING, BORING, BRAZING, DRILLING, WELDING, ETC. SHALL HAVE PRIOR WRITTEN
- APPROVAL OF ARCHITECT AND STRUCTURAL ENGINEER. ALL CLEANOUTS SHALL BE INSTALLED WHERE READILY ACCESSIBLE. THE CONTRACTOR SHALL COORDINATE ALL CLEANOUT LOCATIONS WITH
- EQUIPMENT, CABINETS, ETC., AND THE ARCHITECT PRIOR TO ANY INSTALLATION. CONTRACTOR TO PROVIDE WATER HAMMER ARRESTORS AS MANUFACTURED BY JAY R. SMITH. WATER HAMMER ARRESTORS SHALL BE INSTALLED
- PER MANUFACTURER'S RECOMMENDATIONS ON ALL DOMESTIC WATER BRANCH LINES SERVING FIXTURES. 12 ALL PLUMBING FIXTURE VENTS TO TERMINATE A MIN. OF 12 INCHES FROM ANY VERTICAL SURFACE AND 10 FEET FROM ANY OUTSIDE AIR INTAKES.
- 13 ALL VALVES, UNIONS, ETC. TO BE SAME SIZE AS PIPE UNLESS OTHERWISE INDICATED ON DRAWINGS.
- CONTRACTOR SHALL COORDINATE LAYOUT OF ALL BELOW GRADE PIPING AND COMPONENTS WITH GENERAL CONTRACTOR PRIOR TO BID TO DETERMINE EXTENT OF REQUIRED SAW CUTTING, EXCAVATION, AND SUBSEQUENT REPAIR/RESTORATION OF ALL AFFECTED HARDSCAPE AND SOFTSCAPE SURFACES. ALL SUCH ITEMS SHALL BE INCLUDED IN BID.
- BEFORE FABRICATION OR INSTALLATION THE CONTRACTOR SHALL VERIFY EXACT LOCATIONS OF ALL MECHANICAL EQUIPMENT AND EQUIPMENT PROVIDED UNDER ANOTHER SECTION OF SPECIFICATIONS. EXACT ROUGH-IN LOCATIONS AND REQUIREMENTS SHALL BE COORDINATED IN FIELD.
- 16 ALL POINTS OF CONNECTION SHALL BE COORDINATED WITH THE GENERAL CONTRACTOR PRIOR TO BID.
- 17 ALL WASTE AND VENT PIPING SHALL SLOPE AT 2% UNLESS OTHERWISE INDICATED.

FRAMING.

- ALL VALVES, WATER HAMMER ARRESTORS OR OTHER EQUIPMENT SHOWN IN WALLS OR ABOVE NON-ACCESSIBLE CEILINGS SHALL BE INSTALLED BEHIND AN ACCESS PANEL.
- THESE DRAWINGS SHALL BE READ IN CONJUNCTION WITH AND BE CONSIDERED TO BE A PART OF SEPARATE AND COMPLETE MECHANICAL
- CONNECTION BETWEEN INCOMPATIBLE MATERIALS ABOVE GRADE AND INSIDE BUILDING SHALL BE MADE WITH TWO (2) DIELECTRIC UNIONS SEPARATED BY A SIX INCH (6") SECTION OF RED BRASS PIPE.
- ALL EXTERIOR GAS COCKS, WATER SHUT OFF VALVES AND/OR SEWER CLEANOUTS BELOW GROUND SHALL BE INSTALLED IN YARD BOXES WITH THE COVERS CONSPICUOUSLY MARKED "GAS", "WATER", AND "SEWER" RESPECTIVELY.
- THE CONTRACTOR SHALL VERIFY THE EXACT ELEVATIONS AND LOCATION OF EXISTING DRAINAGE SYSTEM PIPING PRIOR TO CONNECTION OF ANY
- ALL HORIZONTAL PIPING LINES EXTENDED AND CONNECTED TO EQUIPMENT SHALL BE RUN AT THE HIGHEST POSSIBLE ELEVATIONS AND NOT LESS THAN 6" ABOVE THE FLOOR TO PROVIDE CLEARANCE FOR CLEANING. AT WALL OR COLUMN LOCATIONS, PIPING ROUGH-IN SHALL BE STUBBED IN WALLS WHENEVER POSSIBLE
- THE CONTRACTOR SHALL BE RESPONSIBLE FOR PATCHING AND REPAIRING ALL AREAS WHICH ARE DAMAGED BY HIS OPERATIONS. IN ADDITION, THE 24 CONTRACTOR SHALL RESTORE TO THEIR ORIGINAL CONDITION ALL EXISTING TO REMAIN STRUCTURE AND NEW CONSTRUCTION DAMAGED BY HIS
- OPERATIONS. THE CONTRACTOR SHALL BE RESPONSIBLE FOR PATCHING AND REPAIRING ALL PAVED AREAS WHICH ARE EXCAVATED AND/OR DAMAGED BY HIS OPERATIONS. IN ADDITION, THE CONTRACTOR SHALL RESTORE TO THEIR ORIGINAL CONDITION ALL PLANTED AREAS DAMAGED BY HIS OPERATIONS.
- 26 ALL PATCHING AND REPAIRING OF CONCRETE PAVING AND/OR WALKS SHALL BE UNDER ANOTHER SECTION OF THE SPECIFICATIONS.
- ALL EXISTING PIPING DAMAGED DURING EXCAVATION SHALL BE REPAIRED WITH MATERIALS TO MATCH EXISTING BY THE CONTRACTOR AT NO COST TO THE OWNER.
- ALL CUTTING OF EXISTING PAVING, WALKS AND/OR FLOORS SHALL BE BY MACHINE SAW CUTTING. HOLES FOR PIPES IN CONCRETE WALLS OR FLOORS SHALL BE DONE BY CORE DRILLING EQUIPMENT.
- ALL PIPING, EXCEPT PIPING OF NONFERROUS MATERIAL, INSTALLED WITHIN THE GROUND SHALL BE PROTECTED AGAINST CORROSION BY A PROTECTIVE COVERING SUITABLE FOR THE PURPOSE AND SUBJECT TO THE APPROVAL OF THE BUILDING OFFICIAL. ANY PIPING SUBJECT TO UNDUE CORROSIVE ACTION SHALL BE PROTECTED IN A MATTER SUITABLE FOR THE PURPOSE AND SUBJECT TO THE APPROVAL OF THE BUILDING OFFICIAL
- ALL PENETRATIONS AND OPENINGS IN PARTY WALLS AND ROOF/FLOOR/CEILING ASSEMBLIES DUE TO PLUMBING WORK SHALL BE SEALED LINED, INSULATED OR OTHERWISE TREATED TO MAINTAIN THE REQUIRED FIRE AND SOUND RATING.

	PLUMBING	GLEGEND
SYMBOL	ABBREVIATION	DESCRIPTION
	W	SANITARY WASTE/SEWER PIPING
GW	GW	GREASE WASTE PIPING
SD	SD	STORM DRAIN PIPING
OFD	OFD	OVERFLOW DRAIN PIPING
	V	WASTE/SANITARY VENT PIPING
GV	GV	GREASE VENT PIPING
7////		DEMO PIPING
	(E)W	EXISTING SANITARY SEWER PIPING
	(E)V	EXISTING SANITARY VENT PIPING
	CW	DOMESTIC COLD WATER PIPING
	HW	DOMESTIC HOT WATER PIPING
	HWR	DOMESTIC HOT WATER RETURN PIPING
	(E)CW	EXISTING COLD WATER PIPING
	(E)HW	EXISTING HOT WATER PIPING
	(E)HWR	EXISTING HOT WATER RETURN PIPING
G	G	NATURAL GAS PIPING
MPG	MPG	MEDIUM PRESSURE NATURAL GAS PIPING
G	(E)G	EXISTING NATURAL GAS PIPING
MPG	(E)MPG	EXISTING MEDIUM PRESSURE NATURAL GAS PIPIN
CD	CD	CONDENSATE DRAIN PIPING
С		PIPE GOING DOWN
0		PIPE GOING UP
2		TEE
φ ⊚	FCO	FLOOR CLEANOUT/CLEANOUT TO GRADE
œ		P-TRAP
•	POC	POINT OF CONNECTION
ļi	WCO	WALL CLEANOUT
П		PIPE CAP
+	НВ	HOSE BIBB
M	SOV	SHUT-OFF VALVE
	SOVAP	SHUT-OFF VALVE IN ACCESS PANEL
	SOVYB	SHUT-OFF VALVE IN YARD BOX
IV~		PLUG VALVE
A		GAS COCK VALVE
И		CHECK VALVE
<b></b>	FD	FLOOR DRAIN

#### LIST OF APPLICABLE CODES

LIST OF CODES AND STANDARDS MODEL CODE EDITIONS EFFECTIVE JANUARY 1, 2016

FS

CONT.

DFM

FR.

BEL.

DN.

VTR

AP

NIC

REF.

S.A.D.

S.M.D.

S.C.D.

S.S.D.

XX-X

FLOOR SINK

**EQUIPMENT OR FIXTURE** 

CONTINUED/CONTINUATION

DISTANCE FROM METER

FROM

BELOW

DOWN

VENT THROUGH ROOF

ACCESS DOOR

NOT IN CONTRACT

REFERENCE

SEE ARCHITECTURAL DRAWINGS

SEE MECHANICAL DRAWINGS

SEE CIVIL DRAWINGS

SEE STRUCTURAL DRAWINGS

SQUARE FEET

2016 CA BUILDING CODE TITLE 24 PART 2 VOLUME #1 AND #2 2016 CA ELECTRICAL CODE TITLE 24 PART 3

2016 CA MECHANICAL CODE TITLE 24 PART 4

2016 CA PLUMBING CODE TITLE 24 PART 5

2016 CA FIRE CODE TITLE 24 PART 9

2016 CA BUILDING STANDARDS TITLE 24 PART 9

				7	F	LUM	IBING F	IXIU	RE SCI	HEDULE	-		
FIXTU	JRE	MARK	ROU	GH IN C	WASTE	ONS VENT				DESCRI	PTION		
WAT CLOS		WC-1	HVV 	1"	4"	2"	1/2" TOP SPU ELONGATED, FLUSHOMETE	D. SEAT CO SOLID POLY ER 1.28 GPF	VER: KOHLE PROPYLENI , BRASS COI	R K-4731-C STI E PLASTIC. FLU NSTRUCTION,	RONGEHOLD OPEN ISH VALVE: KOHLER	IG, NON-HOLD OPEN	JET,1
WAT CLOS (AD	SET	WC-2	-	1"	4"		1/2" TOP SPU ELONGATED, FLUSHOMETE	D. SEAT CO SOLID POLY ER 1.28 GPF	VER: KOHLE PROPYLENI BRASS CO	R K-4731-C STI E PLASTIC. FLU NSTRUCTION,	RONGEHOLD OPEN ISH VALVE: KOHLER	IG, NON-HOLD OPEN	JET,1
URIN	IAL	<u>UR-1</u>	<u>-</u>	3/4"	2"	2"		ER K-13520	EXPOSED F	LUSHOMETER		OUT, 3/4" TOP SPUD. F INSTRUCTION, 3/4" SF	
URIN (AD		<u>UR-2</u>	-	3/4"	2"	2"		ER K-13520	EXPOSED F	LUSHOMETER		OUT, 3/4" TOP SPUD. F INSTRUCTION, 3/4" SF	
LAVAT	ORY	<u>L-1</u>	1/2"	1/2"	2"	2"	AND OPTION 807-E2805-66 BRASS SPOU	AL SOAP DIS 5PSHCP DE IT, 4 1/8" CE	SPENSER HO CK MOUNTE NTER TO CE	DLE ON RIGHT D SINGLE HOL NTER, VANDAL	SIDE. FAUCET: CHIC E METERING FAUCE	T, CHROME PLATED, ( FON, MECHANICAL MIX	CAST
LAVAT (AD	The second secon	<u>L-2</u>	1/2"	1/2"	2"	2"	AND OPTION 807-E2805-66 BRASS SPOU	AL SOAP DIS 5PSHCP DE IT, 4 1/8" CE	SPENSER HO CK MOUNTE NTER TO CE	DLE ON RIGHT D SINGLE HOL NTER, VANDAL	SIDE. FAUCET: CHIC E METERING FAUCE	T, CHROME PLATED, ( ΓΟΝ, MECHANICAL ΜΙ	CAST
LOOR	DRAIN	<u>FD-1</u>	-	-	2"	2"	JAY R SMITH STRAINER HE				KEL BRONZE STRAI	NER WITH ADJUSTAB	LE
WA		WCO-1	-	-	2"	2"	JAY R SMITH	#4420 TAPI	ER THREAD	PLUG WITH RO	UND COVER.		
RAP PI	RIMER	<u>TP-1</u>	_	1/2"	-	_	PRECISION POPERATED.	LUMBING P	RODUCTS P	2-500 TRAP PR	IMER, CORROSION F	RESISTANT BRASS, PI	STON
EQUIR	EMENTS	REFER	TO SPE	CIFICAT	TION SECT	ION 22 0	0 00 FOR ADD	ITIONAL RE	QUIREMENT			O NOT INCLUDE ALL	
							Ва	sed on 2016	CPC				
					FIX	ΓUR	E CAI	LCUL	ATIO	N SHE	ET		
		Fixture				Sym	nbol Units*	t water Total	Units*	d water Total		Waste Units Total	
	2	Water Urinal	Closet	(FV)		V	/C IR		5 2	15 4		4 12 4	
	3	Lavato	ries				0.75	2.25	1	3		1 3	
	1			or Mor	o Basin	S	S 2.25	2.25	3	3		3 3	
-	1		ng Four				F		0.5	0.5		0.5 0.5	
										The same and the s			

	FIXT	URE	CAL	CUL	ATIO	N SHEET		
			Hot v	vater	Colo	l water	Was	ste
Quantity	Fixture Description	Symbol	Units*	Total	Units*	Total	Units	Total
3	Water Closet (FV)	WC			5	15	4	12
2	Urinal	UR			2	4	2	4
3	Lavatories	L	0.75	2.25	1	3	1	3
1	Sink, Service or Mop Basin	SS	2.25	2.25	3	3	3	3
1	Drinking Fountain	DF			0.5	0.5	0.5	0.5
2	Floor drain, 2"	FD					4	8
			Total	4.5	Total	25.5	Total	30.5
			GPM	4	GPM	38	Size 2%	4"
			Size	3/4"	Size	2"	Size 1%	4"




394-A Umbarger Rd San Jose, CA 95111 www.ArtikA3.com

Consultant Seal

8517 Earhart Rd, Suite 230 Oakland, CA 94621

510-569-2000



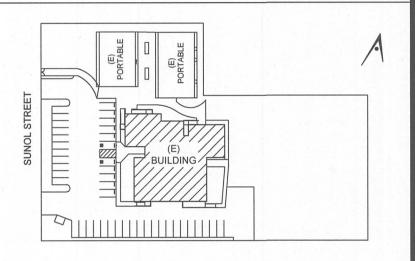

Project Title

# SUNOL COMMUNITY SCHOOL

**ACCESS & BATHROOMS** 250 SUNOL STREET SAN JOSE, CA 95126

SANTA CLARA COUNTY OFFICE OF EDUCATION

No	Revisions/Submissions	Date
1	DSA SUBMITTAL	06/28/2017
2	DSA BACKCHECK SUBMITTAL	09/28/2017

**Drawing Title** 

# PLUMBING GENERAL NOTES, LEGEND & SCHEDULE

Regulatory Agency Approval

DIV. OF THE STATE ARCHITECT OFFICE OF REGULATION SERVICES 01-116854 M FLS / SS DATE SEP 28 2017

Architect Seal (O) Exp. 03-31-19

File Number

Project No.

Application Number

Drawing No

SHEET INDEX LEGEND, GENERAL NOTES, CALCS & SCHEDULES PLUMBING FLOOR PLAN - DEMO AND NEW


PLUMBING CEILING PLAN - DEMO AND NEW

M2.0

P0.1


06/27/2017

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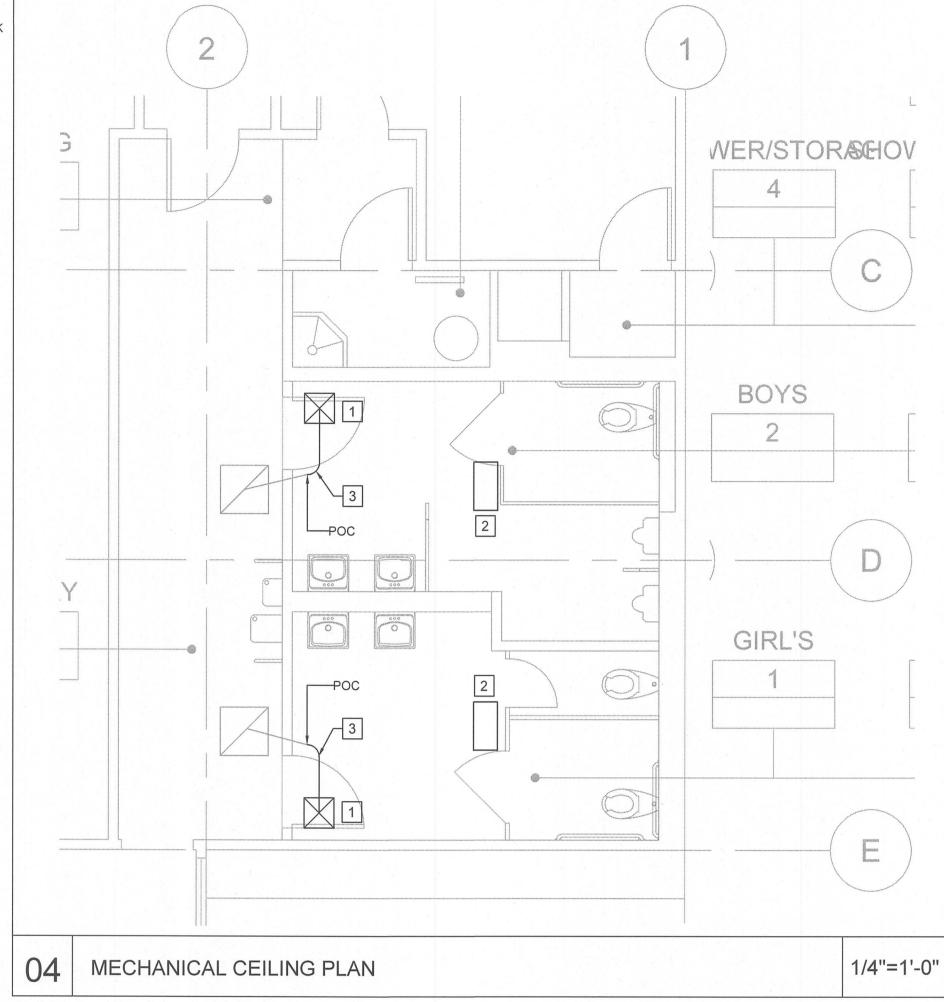
### **DEMO SHEET NOTES:**

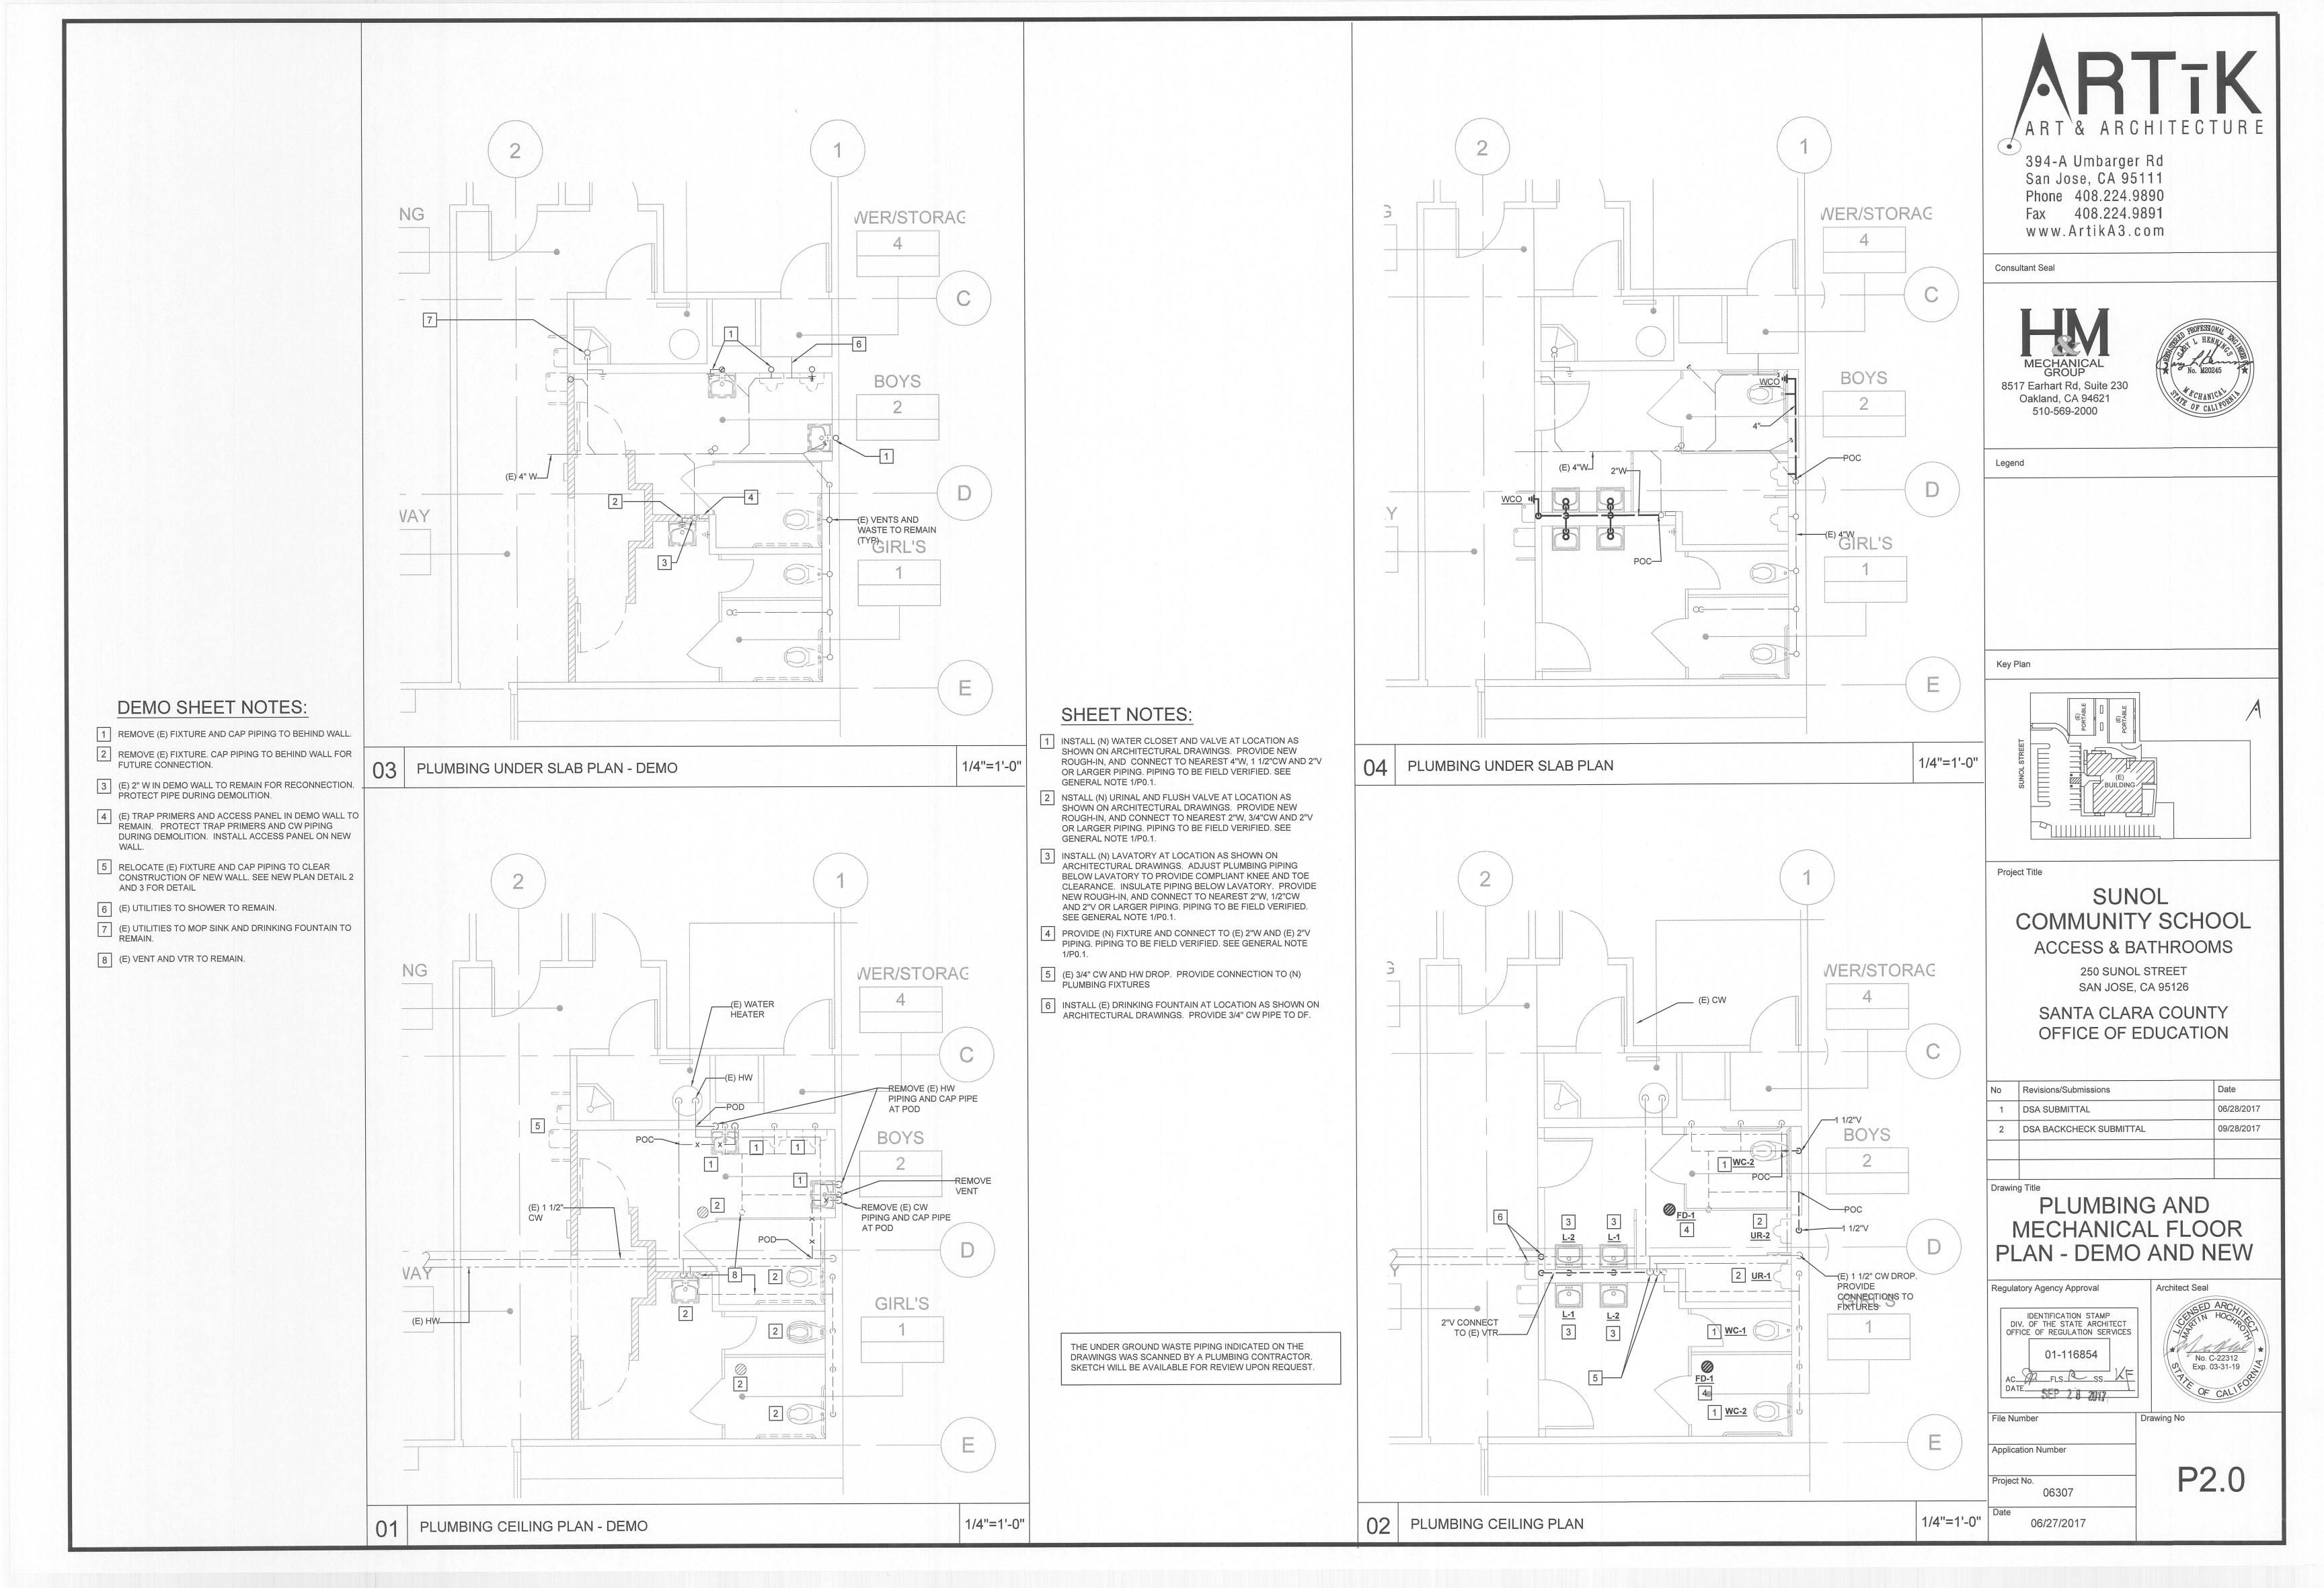- 1 RELOCATE (E) CEILING EXHAUST FAN AS SHOWN ON ARCHITECTURAL CEILING PLAN. EXTEND EXHAUST DUCTWORK AND CONNECTION TO FAN.
- 2 REMOVE (E) CEILING EXHAUST REGISTER FOR CLEANING. REINSTALL AT LOCATION AS INDICATED ON THE ARCHITECTURAL CEILING PLAN AFTER THE NEW CEILING INSTALLATION IS COMPLETED.
- (E) FLEXIBLE DUCTWORK AND CEILING DIFFUSER IN CORRIDOR TO REMAIN



## SHEET NOTES:

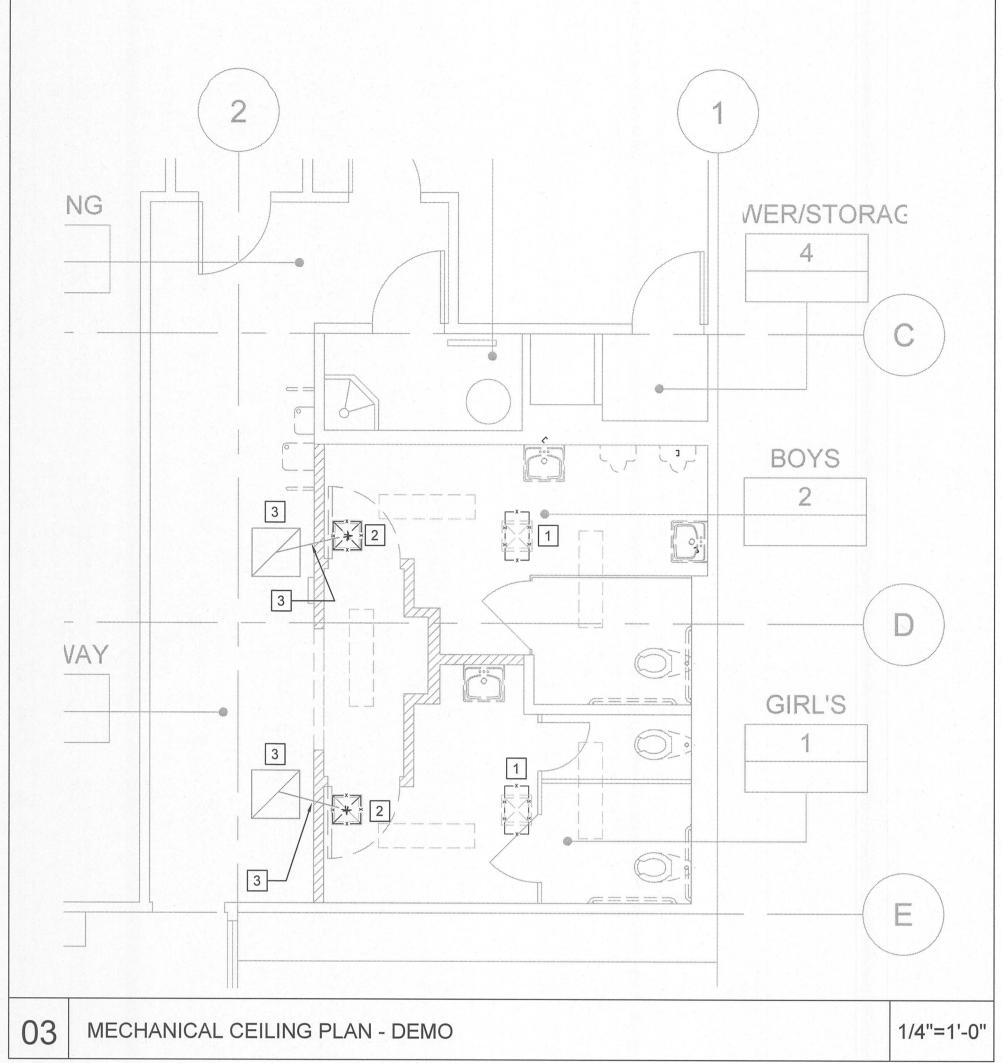- 1 RELOCATED (E) TRANSFER AIR CEILING REGISTER.
- 2 RELOCATED (E) CEILING EXHAUST FAN. EXTEND DUCTWORK AND CONNECT TO FAN.
- 3 INSTALL NEW 10" FLEXIBLE DUCTWORK AND CONNECT TO DIFFUSERS.





394-A Umbarger Rd San Jose, CA 95111 Phone 408.224.9890 Fax 408.224.9891 www.ArtikA3.com

Consultant Seal


8517 Earhart Rd, Suite 230 Oakland, CA 94621

510-569-2000



Legend

Key Plan

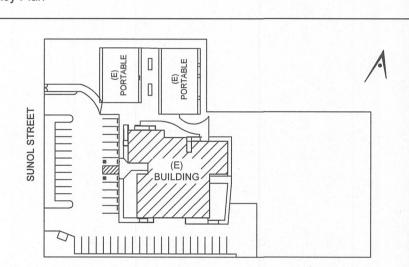

# SUNOL COMMUNITY SCHOOL

ACCESS & BATHROOMS


250 SUNOL STREET SAN JOSE, CA 95126

SANTA CLARA COUNTY OFFICE OF EDUCATION

No	Revisions/Submissions	Date
1	DSA SUBMITTAL	06/28/2017
2	DSA BACKCHECK SUBMITTAL	09/28/2017

# MECHANICAL CEILING DEMO AND NEW PLAN

Regulatory Agency Approval

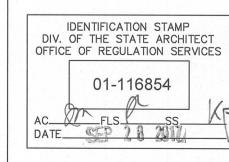

No. C-22312 Exp. 03-31-19

File Number

Project No.

Application Number

Drawing No

06/27/2017

M2.0

- 2. PRIOR TO SUBMITTING PROPOSAL, BIDDER SHALL EXAMINE ALL GENERAL CONSTRUCTION DRAWINGS. VISIT CONSTRUCTION SITE AND ATTEND THE PRE-BID MEETING TO BE FAMILIAR WITH EXISTING CONDITIONS UNDER WHICH HE WILL HAVE TO OPERATE AND WHICH WILL IN ANYWAY AFFECT THE WORK UNDER THIS CONTRACT. NO SUBSEQUENT ALLOWANCE WILL BE MADE IN THIS CONNECTION IN BEHALF OF THE CONTRACTOR FOR ANY ERROR OR NEGLIGENCE ON HIS PART.
- THIS CONTRACTOR SHALL INCLUDE ALL CONTINGENCIES WHICH MAY ARISE AND WHICH MAY BE REQUIRED BY ALTERATION AND DEMOLITION WORK. THIS IS TO INCLUDE ALL REMOVAL. RELOCATION AND REWORKING OF ELECTRICAL OUTLETS, CONDUITS, WIRING AND ITEMS FOR ELECTRICAL EQUIPMENT REQUIRED AND ANY NECESSARY SPLICING OR EXTENSION OF EXISTING CONDUIT AND WIRING SYSTEMS. THE ELECTRICAL CONTRACTOR SHALL VISIT JOB SITE AND DETERMINE EXTENT OF THE WORK.
- FIELD VERIFY TO CONFIRM ALL FIRE RESISTIVE CEILINGS AND WALLS. PROVIDE FIRE STOP SEALS PER UNIFORM BUILDING CODE FOR CONDUIT PENETRATION THROUGH FIRE RESISTIVE FLOORS. WALLS AND CEILINGS.
- 5. ALL ELECTRICAL MATERIALS AND EQUIPMENT SHALL BE LISTED BY UNDERWRITER'S LABORATORIES AND BEAR THEIR LABEL.
- 5. CONDUIT ROUTING SHOWN IS ESSENTIALLY DIAGRAMMATIC. CONTRACTOR SHALL LAYOUT RUNS TO SUIT FIELD CONDITIONS AND THE COORDINATION REQUIREMENTS OF OTHER TRADES. ALL EXPOSED CONDUIT, BOXES, FITTINGS, SUPPORT, ETC. SHALL BE PAINTED TO MATCH ADJACENT SURFACES.
- . THE CONTRACTOR SHALL CONSULT THE ARCHITECTURAL AND OTHER DRAWINGS RELATED TO THIS PROJECT FOR ADDITIONAL WORK TO BE PROVIDED.
- B. THE OWNER RETAINS FIRST SALVAGE RIGHTS TO ALL EXISTING EQUIPMENT REMOVED UNDER THIS CONTRACT. THE ELECTRICAL CONTRACTOR SHALL CONSULT WITH THE OWNER FOR DISPOSITION OF THE EXISTING EQUIPMENT TO BE REMOVED BY HIM. THE CONTRACTOR SHALL INCLUDE IN HIS BID PROPOSAL ALL COSTS RELATED TO THE DISPOSAL OF EXISTING EQUIPMENT REMOVED UNDER THIS CONTRACT.
- ANY POWER SHUTDOWN SHALL BE COORDINATED WITH SCHOOL DISTRICT CONSTRUCTION COORDINATOR. A SHUTDOWN SCHEDULE SHALL BE PRESENTED TO SCHOOL DISTRICT FOR APPROVAL TWO WEEKS PRIOR TO COMMENCEMENT OF WORK. SHUTDOWN SHALL BE PERFORMED IN OVERTIME HOURS IF SO DIRECTED BY SCHOOL DISTRICT
- 10. ALL FEEDER AND BRANCH CIRCUIT CONDUITS SHALL BE INSTALLED CONCEALED IN FINISHED AREA, UNLESS OTHERWISE NOTED. CUT AND PATCH (E) WALL OR CEILING AS REQUIRED. SURFACE TYPE RACEWAY MAY BE PROVIDE IN LIEU OF CONCEALED CONDUITS SEE NOTES 34, 35 AND 36 FOR REQUIREMENTS.
- 11. ALL PENETRATIONS THROUGH FIRE RESISTIVE WALLS SHALL BE TOTALLY SEALED TO PREVENT THE SPREAD OF SMOKE, FIRE, TOXIC GASES, AND WATER THROUGH THE PENETRATION BEFORE, DURING AND AFTER A FIRE CONDITION. THE FIRE RATING OF THE SEALED PENETRATION SHALL BE AT LEAST THAT OF THE WALL INTO WHICH IT IS INSTALLED. THE SEAL SHALL PERMIT THE VIBRATION. EXPANSION AND/OR CONTRACTION OF THE CONDUIT PASSING THROUGH THE PENETRATION WITHOUT THE SEAL CRACKING OR CRUMBLING.
- 12. PROVIDE FLEXIBLE CONDUIT AT BUILDING SEISMIC JOINTS.
- 13. UNLESS OTHERWISE INDICATED, THE MINIMUM SIZE OF CONDUCTORS SHALL BE 12 AWG THWN STRANDED COPPER ONL.Y.
- 14. UNLESS OTHERWISE INDICATED, THE MINIMUM SIZE OF CONDUIT SHALL BE 3/4".
- 15. GREEN INSULATED GROUND CONDUCTORS SHALL BE INSTALLED IN ALL FEEDER AND BRANCH CIRCUIT WIRING.
- 16. PROVIDE LABELS ON ALL EQUIPMENT AND DEVICES, LABELS SHALL BE SELF-ADHESIVE PHENOLIC TYPE AND WHITE LETTER ON BLACK BACKGROUND, PROVIDE BRADY OR DYMO TYPE LABELS (CIRCUIT IDENTIFICATION) FOR ALL SWITCHES AND RECEPTACLES.
- 17. THE CONTRACTOR SHALL PROVIDE TYPEWRITTEN DIRECTORIES FOR ALL ELECTRICAL PANELS INVOLVED IN THIS PROJECT. THE PANEL DIRECTORIES SHALL REFLECT THE AS-BUILT CIRCUITS. ONE COPY OF THE SCHEDULE SHALL BE TAPED TO THE INSIDE OF THE PANEL DOOR, AND ONE COPY SHALL BE SUBMITTED TO THE ENGINEER AS AN "AS-BUILT" DRAWING.
- 18. ALL ELECTRICAL EQUIPMENT SHALL BE BRACED OR ANCHORED TO RESIST A HORIZONTAL FORCE ACTING IN ANY DIRECTION PER CBC REQUIREMENTS.
- 19. THE CONTRACTOR SHALL EMPLOY QUALIFIED AND EXPERIENCED WORKMEN FOR THIS WORK. ALL RESTORATION WORK SHALL BE SUBJECT TO THE APPROVAL OF THE ARCHITECT AND/OR OWNER AND IOR.
- 20. THE CONTRACTOR SHALL BE HELD FULLY RESPONSIBLE FOR THE PROPER RESTORATION OF ALL EXISTING SURFACES REQUIRING PATCHING, PLASTERING PAINTING AND/OR OTHER REPAIRS DUE TO THE INSTALLATION OF ELECTRICAL WORK UNDER THE TERMS OF THIS SPECIFICATION. CLOSE ALL OPENINGS, REPAIR ALL SURFACES, ETC., AS REQUIRED. THIS SHALL INCLUDE ALL WALLS, CEILINGS, ROOFS, PAVEMENT, PLANTERS, ETC.
- 21. WHERE CONDUIT IS ROUTED ON ROOF STRUCTURES. PROVIDE SUPPORT AT 10'-0" O.C. MAXIMUM.
- 22. ALL EXPOSED CONDUIT BELOW 7'-0" SHALL BE RSC AND ALL EXPOSED HARDWARE SHALL BE "HOT DIPPED" GALVANIZED. ALL INTERIOR CONDUITS MAY BE EMT. UNLESS OTHERWISE
- 23. WHERE SURFACE WIRING IS CALLED FOR IN A FINISHED AREA, SURFACE TYPE RACEWAY SYSTEM SHALL BE INSTALLED COMPLETE WITH ALL PROPER FITTINGS, ADAPTERS, OUTLETS, DEVICES COVERS, END CAPS, ETC. AS MANUFACTURED BY PANDUIT OR AN APPROVED EQUAL AND SHALL BE PAINTED TO MATCH COLOR OF ADJACENT WALL OR CEILING. ALL EXPOSED CONDUITS, BOXES AND CABINETS SHALL ALSO BE PAINTED TO MATCH COLOR OF ADJACENT WALL OR CEILING.
- 24. SURFACE TYPE RACEWAY SYSTEM SHALL BE INSTALLED PARALLEL TO, OR AT RIGHT ANGLES TO BUILDING LINES AND ROUTE AROUND SURFACE MOUNTED ITEMS, SUCH AS TACK BOARDS. ETC.

## GENERAL NOTES (CONTINUATION)

- 25. ALL WIRES SHALL BE IN CONDUIT U.O.N.
- 26. GENERALLY, HORIZONTAL RUNS SHALL BE INSTALLED ON THE CORNER BELOW CEILING LINE AS APPROVED BY THE ENGINEER.
- 27. ALL UNDERGROUND CONDUIT SHALL HAVE #12 TRACER WIRE WITH THWN INSULATION UNDER EACH RUN OF THE UNDERGROUND CONDUIT DUCTBAMK AND 6" FOIL MARKER IN TRENCH. TRACE WIRE SHALL EXTEND AT TERMINATION POINTS A MIN. OF 3 FT FROM SUCH SURFACE AND SHALL BE TRAPPED SECURED TO CONDUIT OR ACCEPTABLE EQUIVALENT.
- 28. UPON COMPLETION OF CONSTRUCTION, PAINT ALL EXPOSED ELECTRICAL CONDUITS, DEVICES AND BOXES (UNLESS DEVICES OR BOXES ARE ALREADY PRE-FINISHED) PER SPECIFICATION SECTION 09900, PARAGRAPH 2.3 PAINTING SCHEDULE. PAINT COLOR SHALL MATCH THE EXISTING SURFACES.
- 29. THE CONTRACTOR SHALL MAINTAIN AT THE JOB SITE, AN UP TO DATE "AS BUILT" DRAWING SET. THE "AS BUILT" DRAWING SET SHALL REFLECT ALL APPROVED CHANGES TO THE DESIGN DRAWINGS. THE "AS BUILT" DRAWING SET SHALL BE KEPT CLEAN AND IN GOOD CONDITION AND SHALL BE TURNED OVER TO THE OWNER AT THE COMPLETION OF THE PROJECT. THESE DRAWINGS SHALL BE UPDATED DAILY AND BE CHECKED WEEKLY BY IOR. THE PROGRESS PAYMENT IS TIED TO THEIR COMPLETION.
- 30. UPON COMPLETION OF THE WORK, THE CONTRACTOR SHALL SCHEDULE AND PERFORM A COMPLETE FUNCTIONAL TEST IN THE PRESENCE OF DSA IOR TO DEMONSTRATE TO THE OWNER THAT THE NEW INSTALLATION IS OPERATING AS INTENDED TEST RESULTS SHALL BE SENT TO DISTRICT FOR IOR AND AOR. ANY DEFECTS OR DEFICIENCIES IN THE MATERIALS OR WORK SHALL BE CORRECTED IMMEDIATELY BY AND AT THE CONTRACTOR'S EXPENSE.

### LEGEND

HOMERUN TO PANEL, HASHMARKS INDICATE NUMBER OF #12 AWG WIRES IF MORE THAN (3); (1) INDICATES GROUND.

— CONDUIT AND CONDUCTORS CONCEALS IN WALL OR CEILING

---- CONDUIT AND WIRES CONCEALED IN FLOOR OR UNDERGROUND

SURFACE MOUNTED ELECTRICAL PANELBOARD, 277/480V

SURFACE MOUNTED ELECTRICAL PANELBOARD, 120/208V

RECESSED MOUNTED ELECTRICAL PANELBOARD, 120/208V 

REMOVED INCLUDING WIRES AND CONDUIT UP TO THE NEXT JUNCTION BOX WHICH IS TO REMAIN.

1x4 LIGHT FIXTURE

- - DUPLEX RECEPTACLE NEMA 5-20R, 20 AMP, 120V, +18" A.F.F U.O.N.
- FOURPLEX RECEPTACLE NEMA 5-20R, 20 AMP, 120V, +18" A.F.F U.O.N.
- CEILING MOUNTED DUPPLEX RECEPTACLE, NEMA 5-20R, 20 AMP, 120V
- SINGLE RECEPTACLE, 15A/250V, NEMA TYPE L6-15
- **⊗**, ⊗ EXIT LIGHT FIXTURE
  - EXIT LIGHT WITH EMERGENCY TWIN HEAD LIGHTING
- nCM PDT 9

SENSORSWITCH nLIGHT CEILING MOUNT LOW VOLTAGE STANDARD RANGE / HIGH SENSITIVITY 360° DUAL TECHNOLOGY (DIGITAL PIR + MICROPHONICS) OCCUPANCY SENSOR.

- SENSOR SWITCH nLIGHT DIGITAL POWER PACK WITH INTEGRAL 16A RELAY. 120/277 VAC, CHASE NIPPLE MOUNT. PROVIDE UP TO 40mA BUS CURRENT
- HORSEPOWER RATED MANUAL SWITCH, SQUARE "D" CLASS 2510
- JUNCTION BOX OR PULL BOX, SIZE PER CODE.
- SHEET NOTE REFERENCE, SEE NOTE 1
  - DETAIL TAG. REFER TO DETAIL 1 ON SHEET NUMBER E3.1

### DRAWING INDEX

- ELECTRICAL COVER SHEET
- CERTIFICATE OF COMPLIANCE TITLE 24
- ELECTRICAL DEMOLITION PLAN
- LIGHTING & POWER PLANS
- SCHEDULE AND DETAILS

### LIST OF APPLICABLE CODES

- 2016 CALIFORNIA BUILDING STANDARDS ADMINISTRATIVE CODE (PART 1, TITLE 24, CCR)
- 2016 CALIFORNIA BUILDING CODE (CBC), VOLUMES 1 & 2 (PART 2, TITLE 24, CCR)
- 2016 CALIFORNIA ELECTRICAL CODE (PART 3, TITLE 24, CCR)
- 2016 CALIFORNIA MECHANICAL CODE (PART 4, TITLE 24, CCR)
- 2016 CALIFORNIA PLUMBING CODE (PART 5, TITLE 24, CCR)
- 2016 CALIFORNIA ENERGY CODE (PART 6, TITLE 24, CCR)
- 2013 CALIFORNIA ELEVATOR SAFETY CONSTRUCTION CODE (PART 7, TITLE 24, CCR)
- 2016 CALIFORNIA FIRE CODE (PART 9, TITLE 24, CCR)
- 2016 CALIFORNIA REFERENCE STANDARDS CODE (PART 12, TITLE 24, CCR)
- NFPA 13, 2016 EDITION, THE INSTALLATION OF AUTOMATIC SPRINKLER SYSTEMS, AS AMENDED
- NFPA 14, 2013 EDITION, THE INSTALLATION OF STANDPIPE. PRIVATE HYDRANT AND HOSE SYSTEMS
- NFPA 24, 2016 EDITION, THE INSTALLATION OF PRIVATE FIRE SERVICE MAINS AND THEIR APPURTENANCES
- NFPA 72, 2016 EDITION, NATIONAL FIRE ALARM CODE, AS AMENDED
- 14. 2010 ADA STANDARDS FOR ACCESSIBLE DESIGN.

#### **ABBREVIATIONS**

AMP FF	AMPERE ABOVE FINISHED FLOOR	0.C.	ON CENTER
NP	ACCESS POINT	PA	PUBLIC ADDRESS
BRKR	BREAKER	PH, Ø PNL	PHASE PANEL
CATV CBC	CONDUIT, CLOCK CABLE TELEVISION CALIFORNIA BUILDING CODE	(R) RECEPT.	RELOCATED RECEPTACLE
CCTV CEC CKT	CLOSED CIRCUIT TELEVISION CALIFORNIA ELECTRIC CODE CIRCUIT	SAD	SEE ARCHITECTURAL DRAWINGS
DPS	CONDUIT ONLY WITH PULL ROPE CURRICULUM AND PRESENTATION SYSTEM	STC	SATELLITE TERMINAL CABINET
CSC	CLOCK/SPEAKER CABINET	TRANSF.	
(E)	EXISTING	TB TC	TELEPHONE BOARD TERMINAL CAN
U	FUSE	TYP	TYPICAL
}	GROUND, GUARD	UON	UNLESS OTHERWISE
DF	INTERMEDIATE DISTRIBUTION FRAME		NOTED
MAX	MAXIMUM	٧	VOLT
NDF NIN	MAIN DISTRIBUTION FRAME MINIMUM	W	WATT
MPOE	MAIN POINT OF ENTRY	WG WP	WIRE GUARD WEATHERPROOF
MSTC ATD	MAIN SIGNAL TELEPHONE CABINET MAIN TELEPHONE BOARD		
MTB		XFMR	TRANSFORMER
NEC NL	NATIONAL ELECTRICAL CODE NIGHT LIGHT		

NOT TO SCALE



394-A Umbarger Rd San Jose, CA 95111 Phone 408.224.9890 Fax 408.224.9891 www.ArtikA3.com


Consultant Seal



Legend



Key Plan

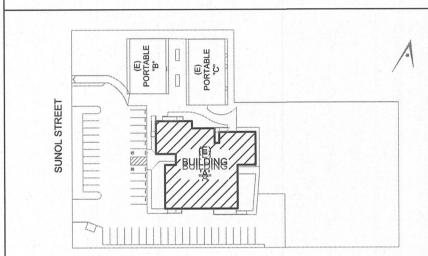

**Project Title** 

SUNOL COMMUNITY SCHOOL RESTROOMS UPGRADE

> 258 SUNOL STREET SAN JOSE, CA 95126

SANTA CLARA COUNTY OFFICE OF EDUCATION

No	Revisions/Submissions	Date
1	DSA SUBMITTAL	06/28/2017
2	DSA BACKCHECK SUBMITTAL	09/28/2017

**Drawing Title** 

ELECTRICAL COVER SHEET


**Architect Seal** Regulatory Agency Approval IDENTIFICATION STAMP DIV. OF THE STATE ARCHITECT OFFICE OF REGULATION SERVICES No. C-22312 Exp. 03-31-19 01-116854 AC FLS SS K FIR OF CALIFO! DATE SEP 2 8 20171

File Number

**Application Number** 

Project No. 06307 06/27/2017 E0.


Drawing No

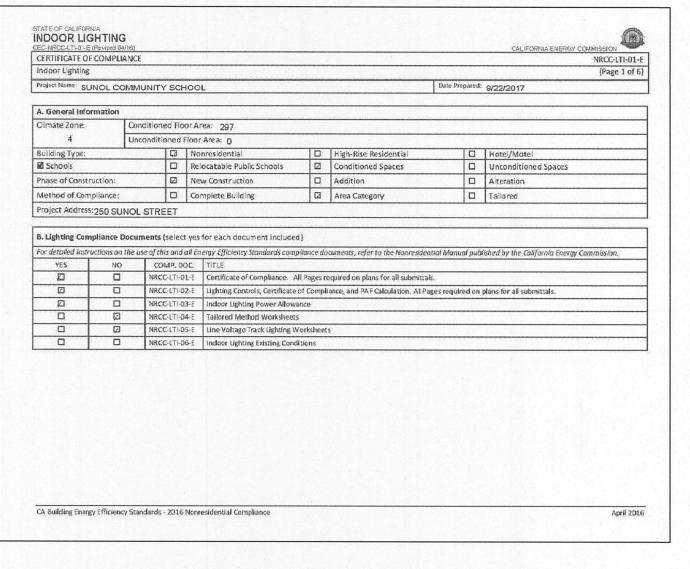


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	ATE OF COI	MPLIANCE					1	VRCC-LTI-01-
ndoor Li	************							(Page 2 of I
roject Nan	sunc	DECOMMUNITY SCHOOL			Date Prepared: 9/22/2017			
C Summ	ary of Allo	wed Lighting Power						
************	*************	conditioned space Lighting must not be combined	for	compliance				***************************************
	***************************************	Indoor Lighting Power for Conditioned Spaces			Indoor Lighting Power for Uncond	itioned Spac	es	
				Watts		Watts  led Lighting		Watts
01		Installed Lighting NRCC-LTI-01-E, Table H, page 5	4	140	Install NRCC-LTI-01-E, Table			0:
02		Portable Only for Offices NRCC-LTI-01-E, Table G, page 4	+					
03		Minus Lighting Control Credits NRCC-LTI-02-E, page 2	-	0	Minus Lighting Cont NRCC-LTI-0:	2-E, page 2	-	0
04		Adjusted Installed Lighting Power (row 1 plus row 2 minus row 3)	=	140	Adjusted Installed Light (row 1 mi	ting Power inus row 3)	=	0
	Co	implies ONLY if installed < Allowed (Box 04 < Box 0	15)		Compiles ONLY if Installed ≤ Allowed	(Box 04 < Bo	x 05	
	0/35% low	Conditioned NRCC-LTI-03-E, page 1 ons with replacement luminaires that have at least er power compared to the original existing lumina ad use the allowed wattage from NRCC-LTI-05, pag	ires,	178	Unconditioned NRCC-LTI-03-E, page  Alterations with replacement luminal res that have lower power compared to the original existing luinstead use the allowed wattage from NRCC-LT	e at least 50/35% uminaires, may		
Declare b YES	y selecting NO	equired Certificates of Installation yes for all of the Certificates that will be submitte Compliance Document/Title		etain copies	and verify forms are completed and signed.)			
Ó		NRCI-LTI-01-E - Must be submitted for all building	ngs			☐ Field Ins	pect	or
0	Ø	NRCI-LTI-02-E - Must be submitted for a lighting to be recognized for compliance.	con'	trol system, i	or for an Energy Management Control System (EMCS),	☐ Field Ins	pect	or
П	Ø	NRCI-LTI-03-E - Must be submitted for a line-vol overcurrent protection panel used to energize o			g integral current limiter, or for a supplementary rack lighting, to be recognized for compliance.	□ Fleid Ins	pect	or
0	Ø	NRCI-LTI-04-E - Must be submitted for two inter conference room, a multipurpose room, or a the			이 경우 아무슨 아이들은 아이들이 아니는 아이들이 아이들이 아이들이 아이들이 아니는 아이들이 아니는 아이들이 아이들이 아니는	☐ Field Ins	pect	or
	Ø	NRCI-LTI-05-E - Must be submitted for a Power	Adju:	stment Facto	r (PAF) to be recognized for compliance.	☐ Field Ins	pect	or
п		NRCI-LTI-06-E - Must be submitted for additional compliance.	l wa	ttage installe	ed in a video conferencing studio to be recognized for	☐ Field Ins	nect	or

CERTIFIC	ATE OF CO			CALIFORNIA ENERGY COMMISSION NRCC-LTI-
Indoor Li				(Page 3)
Project Nar	me! SUNC	L COMMUNITY SCHOOL	Date Prepared: 9	/22/2017
E. Declar	ation of Re	equired Certificates of Acceptance		
Declare b	y selecting	yes for all of the Certificates that will be submitted. (Retain copies	s and verify forms are completed and signed	1
YES	NO	Compliance Document/Title		
Ø		NRCA-LTI-02-A - Must be submitted for occupancy sensors and	automatic time switch controls.	☐ Field Inspector
	Q	NRCA-LTI-03-A - Must be submitted for automatic daylight conti	rois.	☐ Reid Inspector
П	D D	NRCA-LTI-04-A - Must be submitted for demand responsive light	ting controls.	☐ Field Inspector
	Q	NRCA-LTI-05-A - Must be submitted for institutional tuning pow	ver adjustment factor (PAF).	☐ Field Inspector
E Indoor	DITIONED :	Schedule Must Be Filled Out for Conditioned and Unconditioned Space UNCONDITIONED SPACE  chedule and Field Inspection Energy Checklist or lighting power listed on the next 2 pages includes all installed pe		
F. Indoor	r Lighting S actual Indo in Complete in Area Cate	chedule and Field Inspection Energy Checklist or lighting power listed on the next 2 pages includes all installed po Building Method is used for compilance, list each different type of agory Method or Tailored Method is used for compilance, list each	ermanent and planned portable lighting syst f juminaire on separate lines, different type of juminaire by each different	ems: function area on separate lines
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CERTIFICA	ATE OF COMPLIANCE							NR	CC-LTI
Indaor Lig	phting							{	age 5
Project Nam	SUNOL COMMUNITY SCHOOL						Date Prepared: 9/22/2017		
	e Lighting Schedule Must Be Filled Out for Conditioned SPACE UNCONDITIONED SP.		anditione	d Spaces. I	nstalled Li	ighting Pow	er listed on this Lighting Schedule is o	nly for:	
H. Indoo	Lighting Schedule and Field Inspection Energy	Checklist							
	Luminaire Schedule		1	nstalled Wa	itts		Location	Field In	specto
01	02	.03	<del></del>	04	.05	06	07-		08
	Complete Luminaire Description	in di	1	ttage was mined		Page (;			
Name or item Tag	(i.e., 3 lamp fluorescent troffer, F3218, one dimmable electronic ballast)	Watts per Luminaire	CEC Default from NA8	According to §130.0(c)	Number	Total installed Watts in this area (H03 x H05.)	Primary Function area in which these luminaires are installed	Pass	F
A.A1	34.9W LED	34.9	Ø		4	140	Corridor/Restroom/Support		
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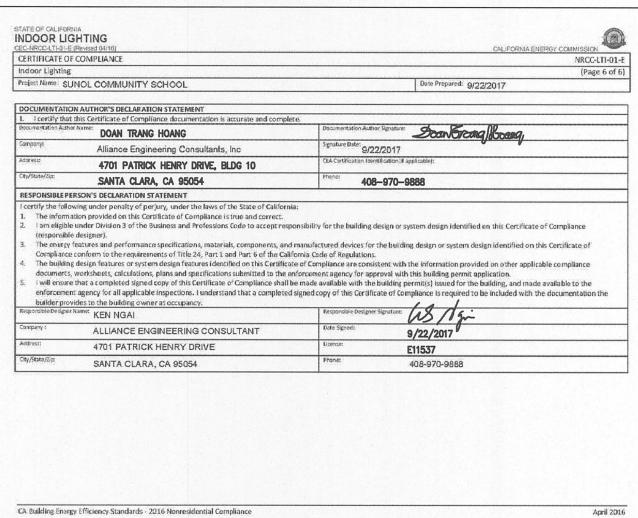


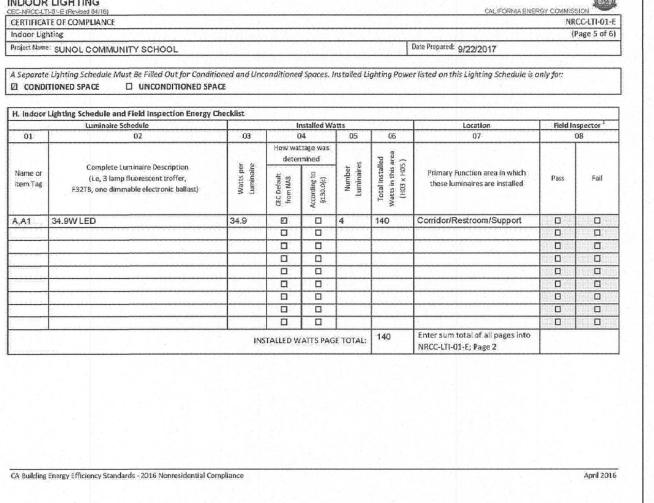



394-A Umbarger Rd San Jose, CA 95111

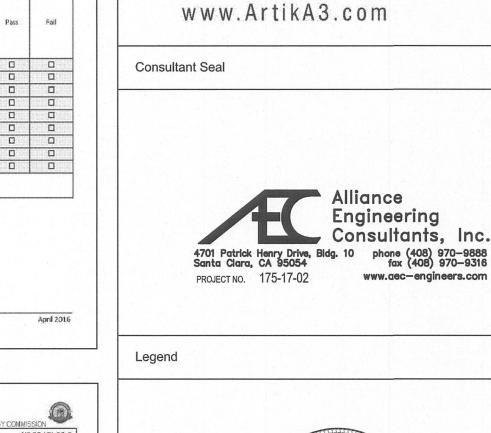Phone 408.224.9890


Fax 408.224.9891




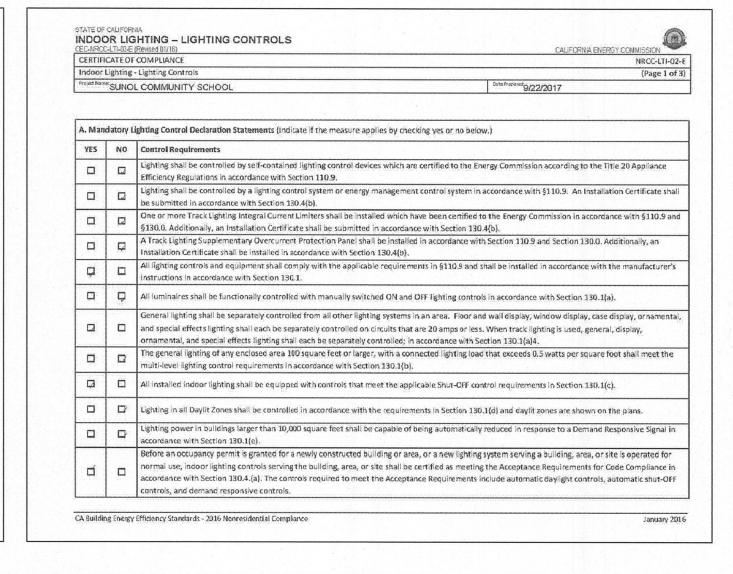


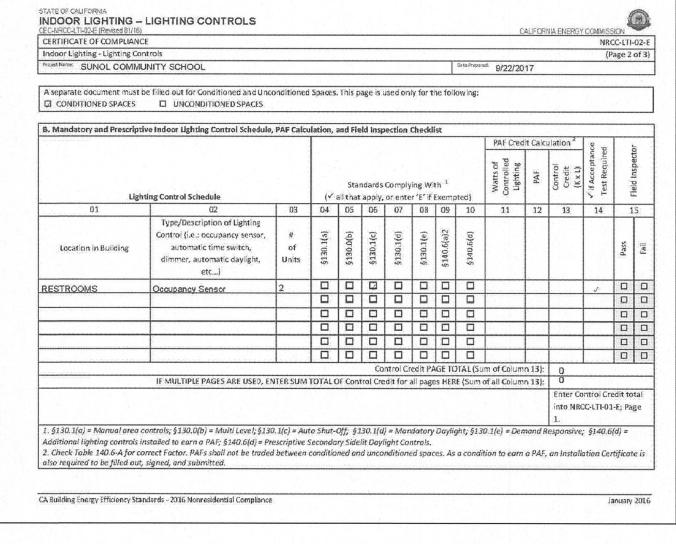


CERTIFICATE OF			CALIFORNIA ENERGY CO	NRCC-LTI-02-I
Indoor Lighting	- Lighting Controls			(Page 3 of 3
Project Name: SUN	IOL COMMUNITY SCHOOL		Date (Frapared: 9/22/2017	
	IN AUTHOR'S DECLARATION STATEMENT Lins Certificate of Compliance documentation is accurate and comp	fata		
Documentation Author		Grownertation Author	Doan Greang Board	
Company:	Alliance Engineering Consultants, Inc.	Signature Date: 9/22	2017	
Address:		CEA Certification Identif	344 (4 C C C C C C C C C C C C C C C C C	
City/9tate/Zip:	4701 PATRICK HENRY DRIVE, BLDG 10	Prone: 400		
	SANTA CLARA, CA 95054	408-	970-9888	
	RSON'S DECLARATION STATEMENT wing under penalty of perjury, under the laws of the State of Californ	nia:		
documents, 5, I will ensure	g design features or system design features identified on this Certific; worksheets, calculations, plans and specifications submitted to the athat a completed signed copy of this Certificate of Compliance shall	enforcement agency for appro be made available with the b	wal with this building permit application. uilding permit(s) issued for the building, and made availabl	e to the
documents, 5. I will ensure enforcemen	worksheets, calculations, plans and specifications submitted to the that a completed signed copy of this Certificate of Compliance shall at agency for all applicable inspections. Lunderstand that a complete iddes to the building owner at occupancy.	ate of Compliance are consistent enforcement agency for appro- be made available with the b	wal with this building permit application; aliding permit(s) issued for the building, and made available e of Compliance is required to be included with the docum	e to the
documents, 5. I will ensure enforcement builder prov Responsible Designer	worksheets, calculations, plans and specifications submitted to the that a completed signed copy of this Certificate of Compliance shall at agency for all applicable inspections. I understand that a complete vides to the building owner at occupancy.  KEN NGAI	ate of Compliance are consistent enforcement agency for appro- be made available with the bild disigned copy of this Certifical Responsible Designer St	wal with this building permit application, illding permit(s) issued for the building, and made available e of Compliance is required to be included with the documents.  Agriculture:   Ag	e to the
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Project Title SUNOL

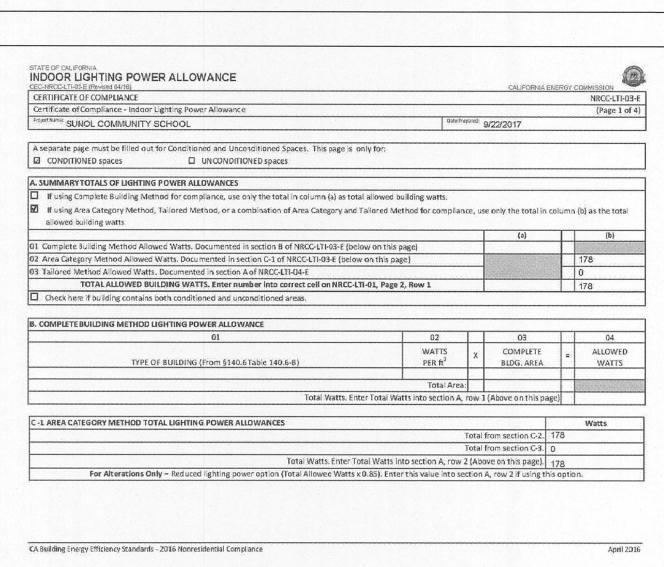COMMUNITY SCHOOL **RESTROOMS UPGRADE** 258 SUNOL STREET

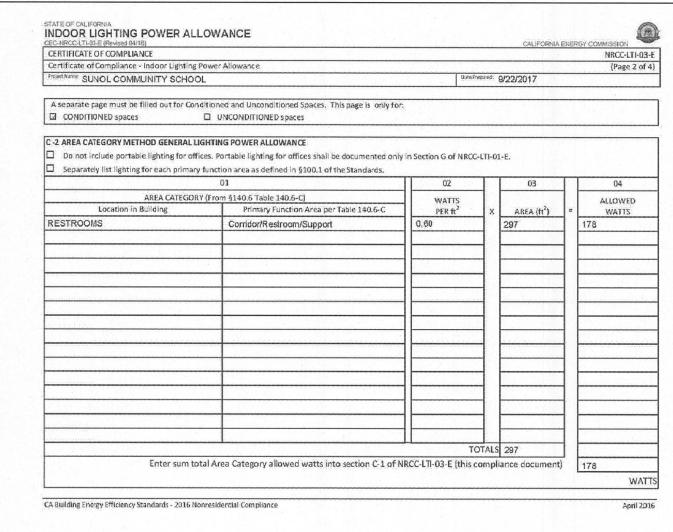SANTA CLARA COUNTY OFFICE OF EDUCATION

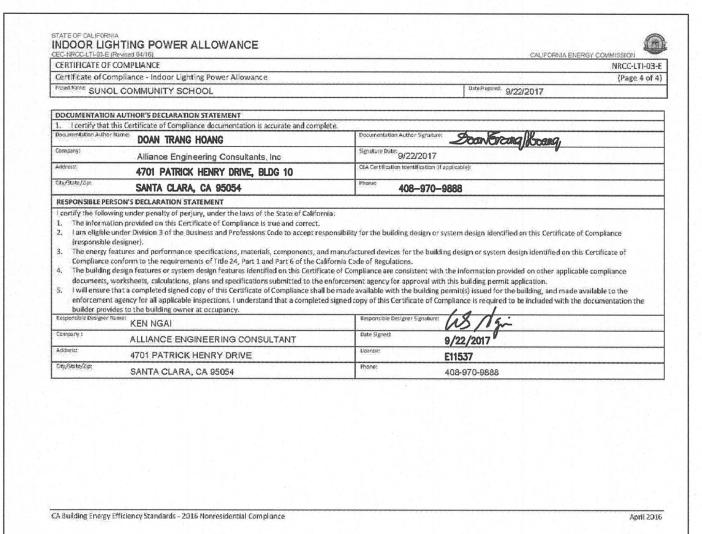SAN JOSE, CA 95126

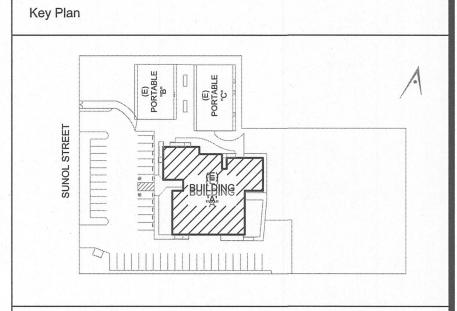No	Revisions/Submissions	Date
1	DSA SUBMITTAL	06/28/2017
2	DSA BACKCHECK SUBMITTAL	09/28/2017

**Drawing Title** 


CERTIFICATE OF **COMPLIANCE TITLE 24** 



Architect Seal
No. C-22312 Exp. 03-31-19

File Number Drawing No **Application Number** Project No.

06307

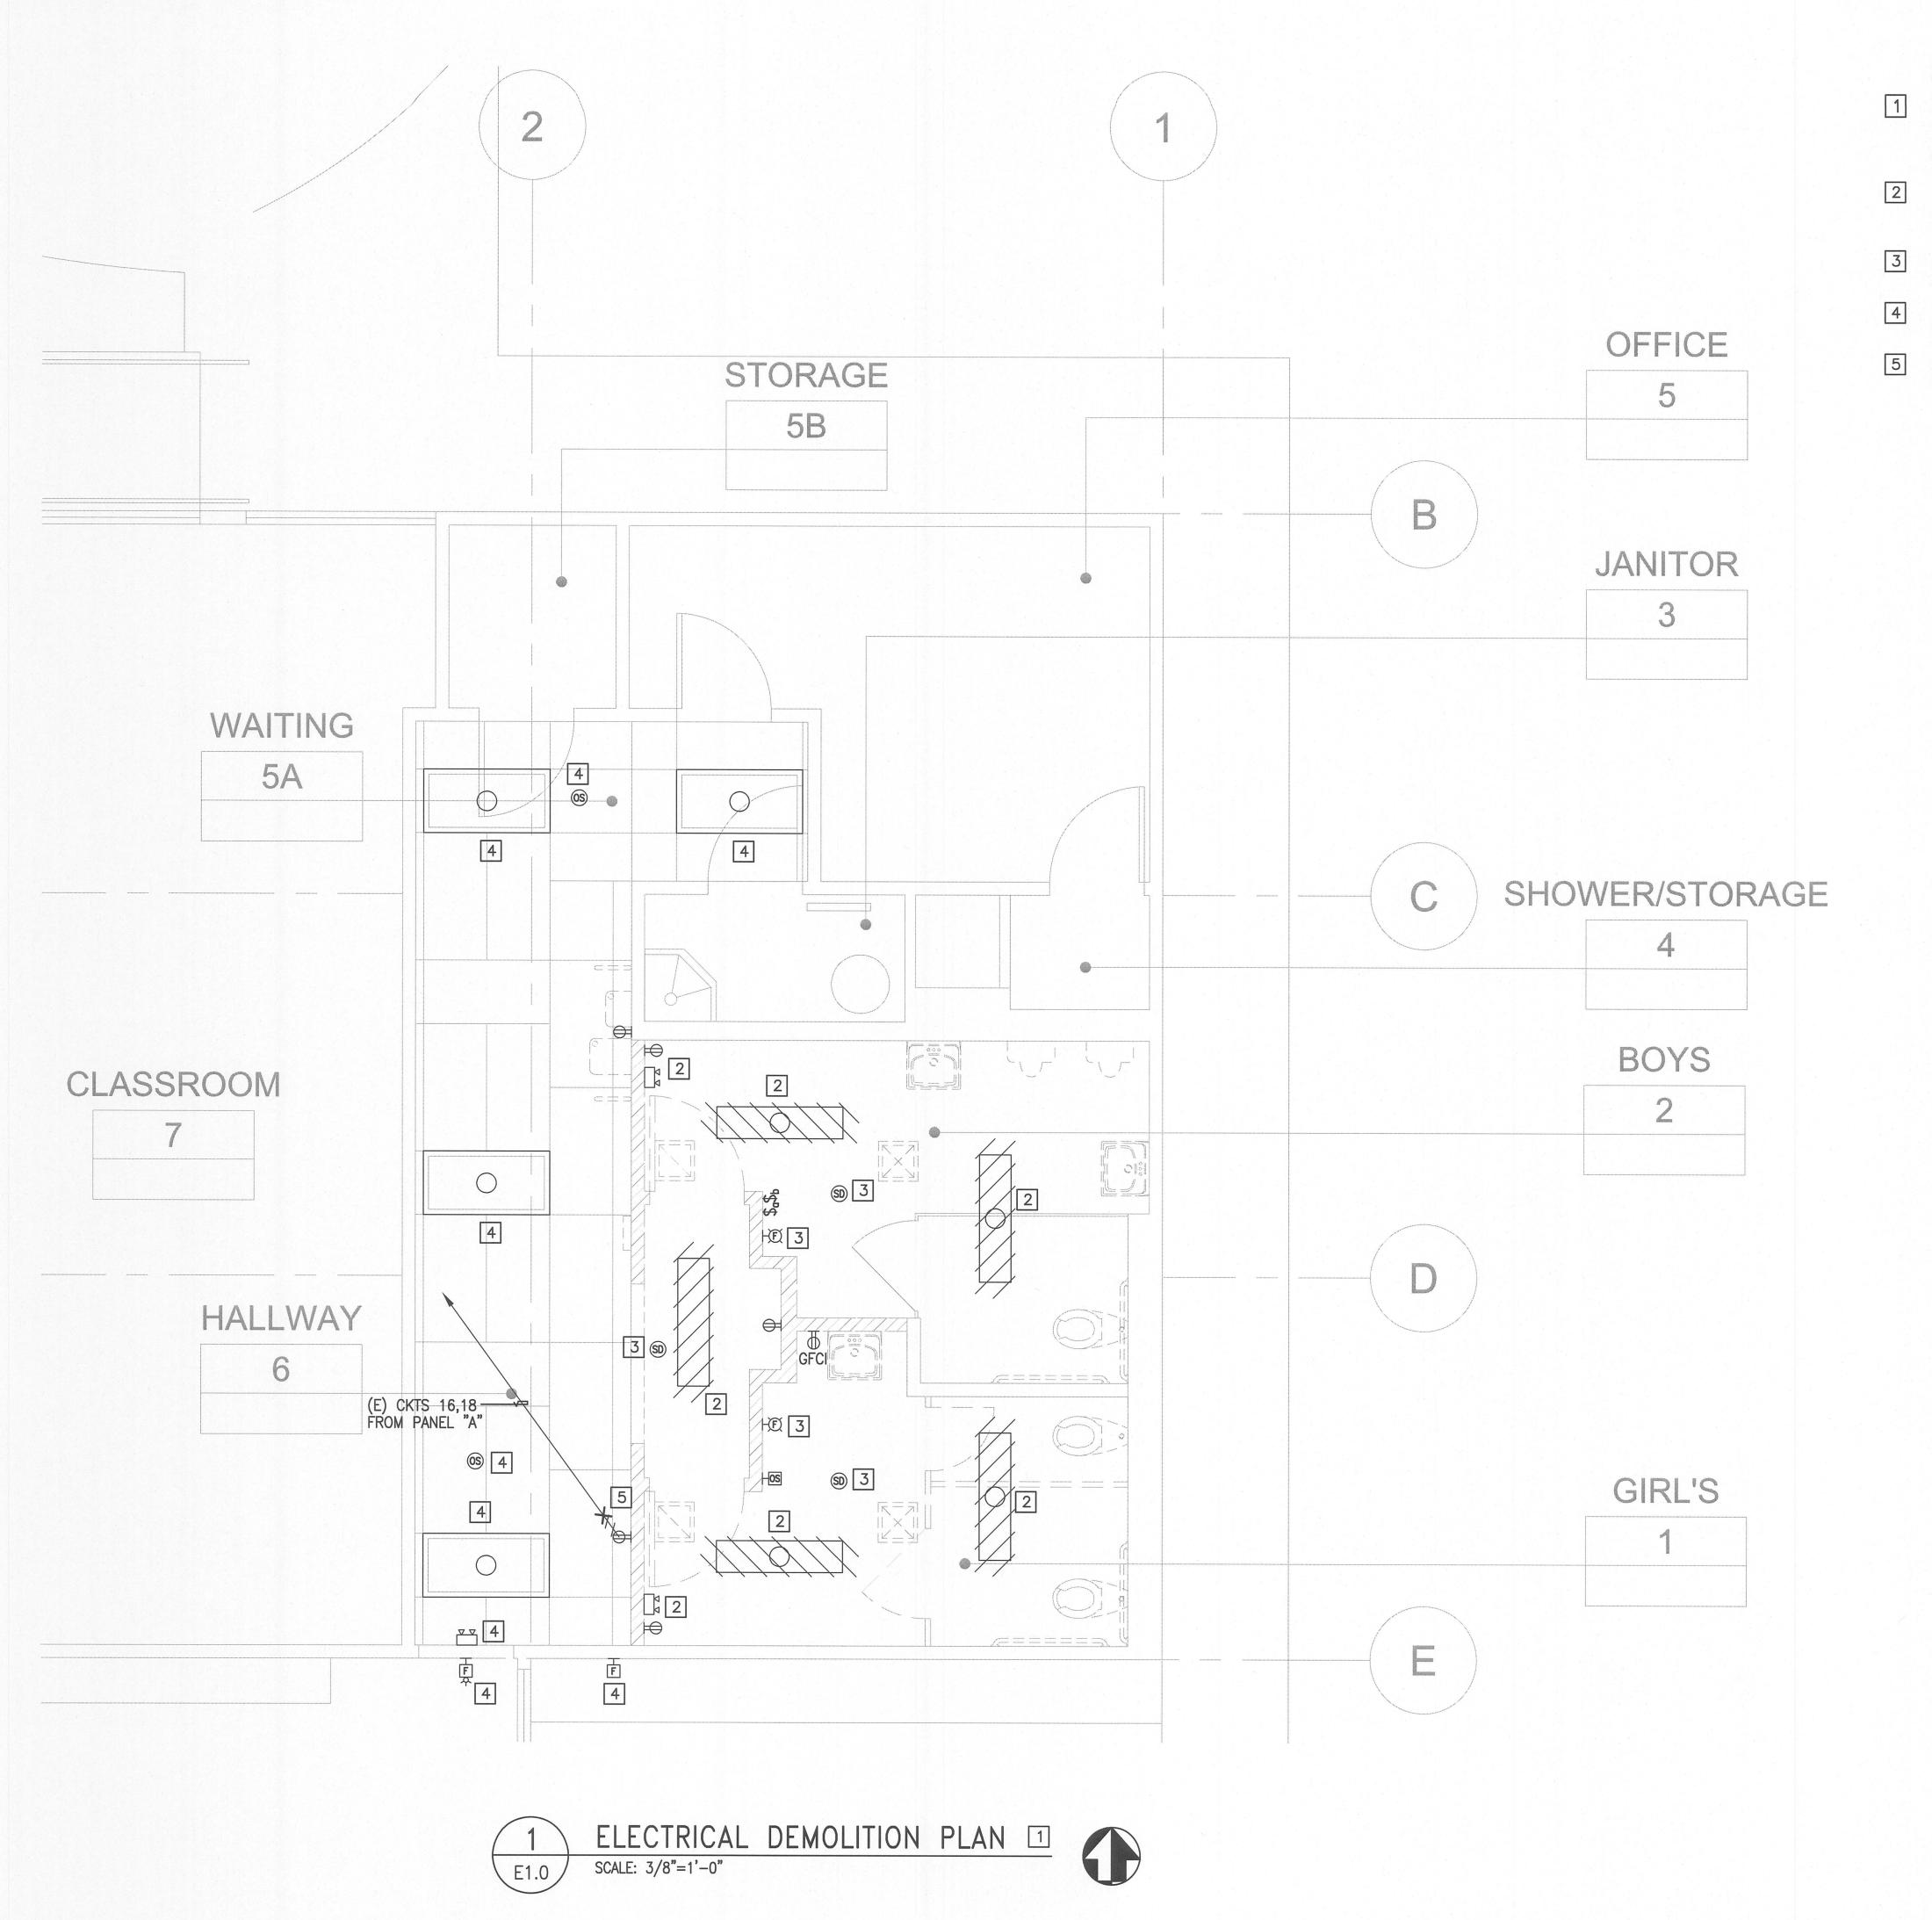

# **DEMOLITION NOTES:**

- ALL ELECTRICAL ITEMS INCLUDING WIRES AND CONDUIT SHOWN ON THIS DRAWING SHALL BE DISCONNECTED AND REMOVED UP TO SOURCE OR THE NEXT JUNCTION BOX, UON.
  - DISCONNECT AND REMOVE (E) LIGHT FIXTURE.
    COIL AND TAPE (E) WIRES IN (E) JUNCTION
    BOX FOR RECONNECTION IN THE (N) WORK.
  - RELOCATE (E) ELECTRICAL ITEM TO (N) LOCATION.
    SEE SHEET E1.2 FOR (N) LOCATION.
- 4 ELECTRICAL ITEM TO REMAIN. MAINTAIN CIRCUIT CONTINUITY.
- 5 SEE NOTE 6 ON SHEET E1.1 FOR OTHER WORK REQUIRED.



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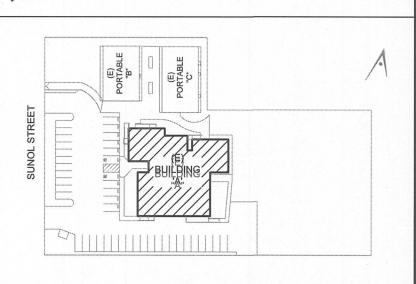
Consultant Seal



Legend



Key Plan



Project Title

# SUNOL COMMUNITY SCHOOL

RESTROOMS UPGRADE

258 SUNOL STREET

SAN JOSE, CA 95126

SANTA CLARA COUNTY OFFICE OF EDUCATION

No	Revisions/Submissions	Date		
1	DSA SUBMITTAL	06/28/2017		
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ELCTRICAL DEMOLITION PLAN



Architect Seal

SED ARCHITECTURE

No. C-22312
Exp. 03-31-19

PARCHITECTURE

No. C-22312
Exp. 03-31-19

File Number


Application Number

Project No. 06307


06/27/2017

E1.0

Drawing No

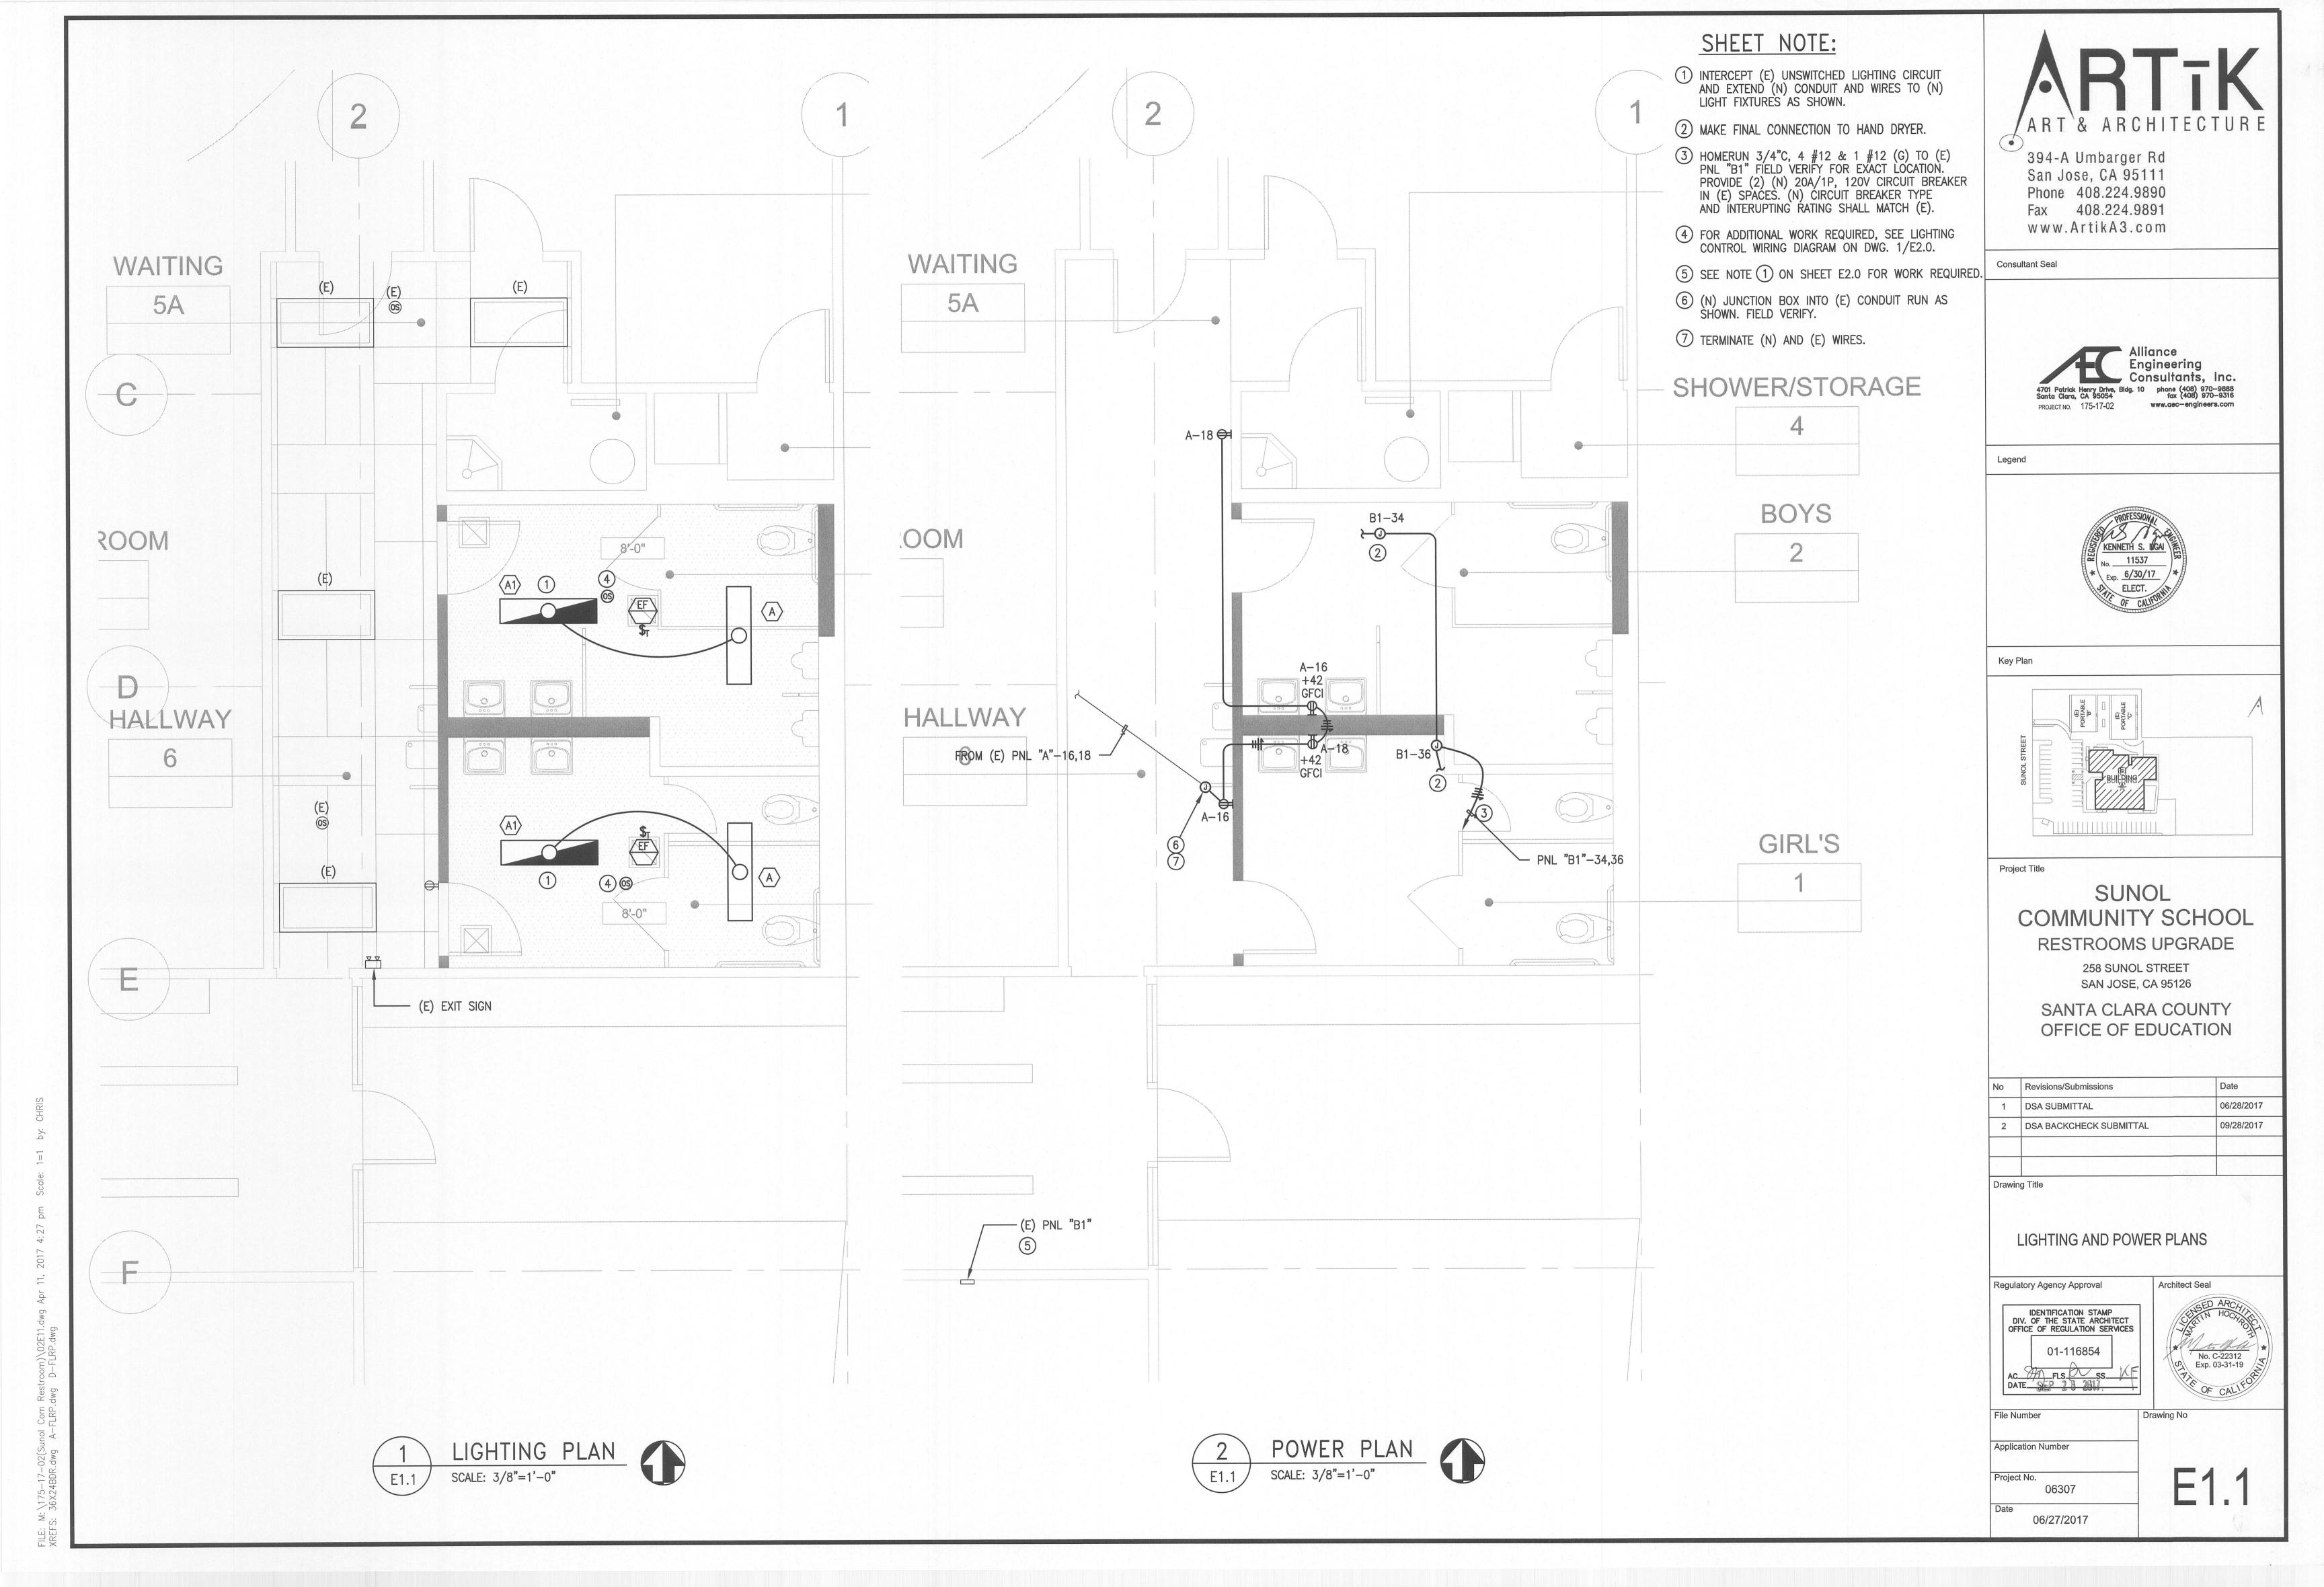


1) UTILIZE (E) SPARE CIRCUIT BREAKER. SIZE AS SHOWN.

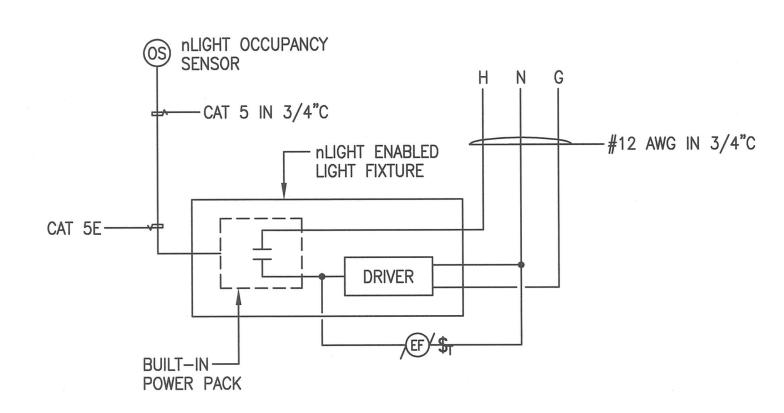

# RESTROOM LIGHTING FIXTURE WIRING DIAGRAM WITH EXHAUST FAN


NOT TO SCALE

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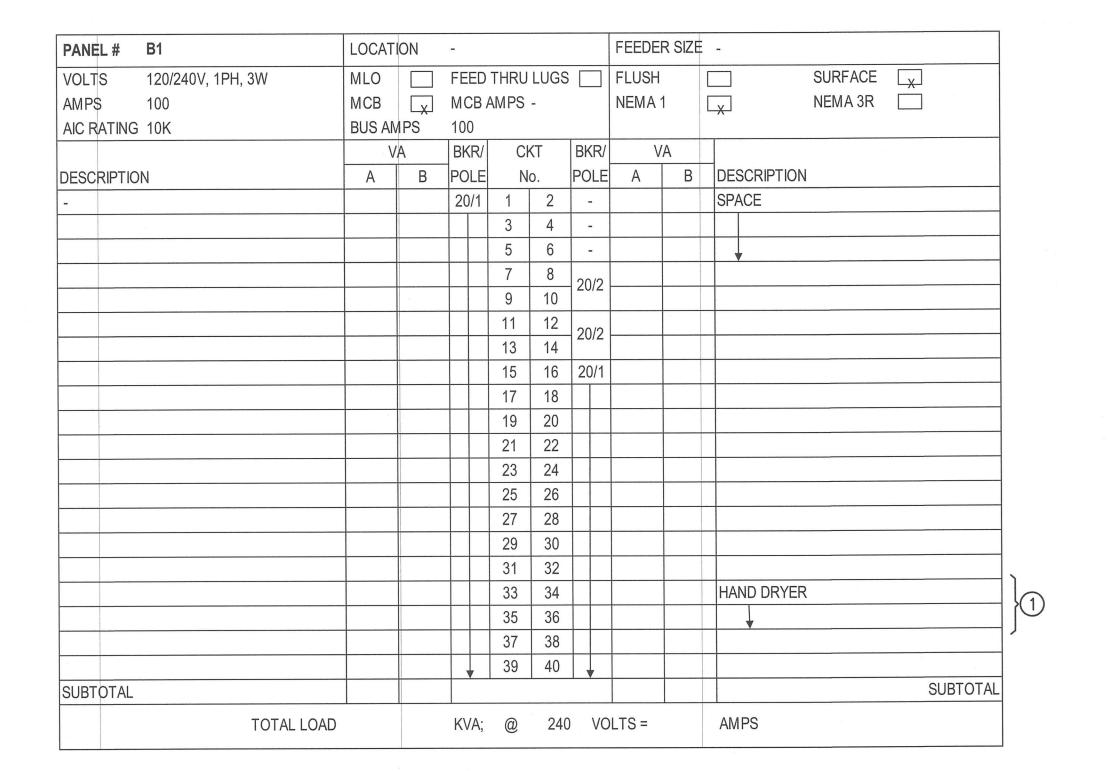
### STUD WALL PARTITION

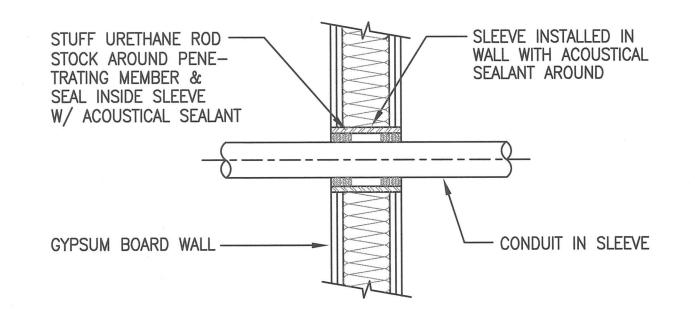



/	3	SURFACE	MOUNTED	LIGHT	FIXTURE	DETAIL
	E2.0	NOT TO SCALE				

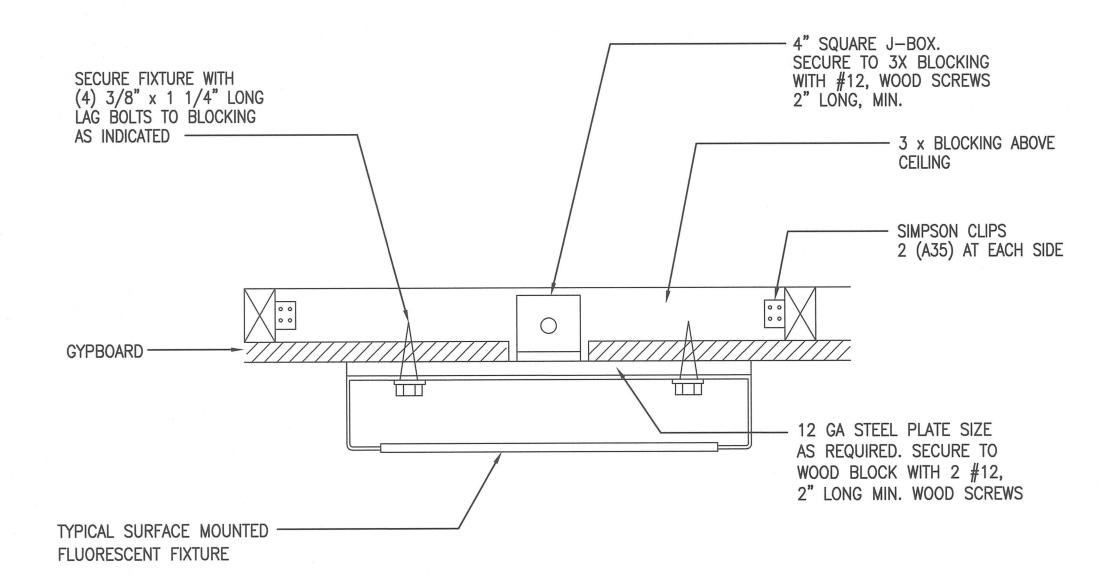	LIGHTING FIXTURE SCHEDULE											
MARK	MANUFACTURERS MODEL NO.	QTY.	LAMPS TYPE	TOTAL WATTS	VOLTS	MOUNTING	DESCRIPTION AND REMARKS					
A	LITHONIA CAT #STL4-40L-EZB-LP830-N100	_	LED	34.9	MULTI	SURFACE	1'x4' LED LIGHT FIXTURE WITH WHITE POLYESTER POWDERCOAT FINISH					
(A1)	LITHONIA CAT #STL4-40L-EZB-LP830- N100-EL14L	_	LED	34.9	MULTI	SURFACE	SAME AS TYPE "A" LIGHT FIXTURE EXCEPT WITH EMERGENCY BATTERY PACK					
(X)	LITHONIA CAT #LED SW16-120-ELNSD	_	LED	10.2	120	UNIVERSE	LED EXIT LIGHT FIXTURE WITH GREEN LETTERS ON WHITE BACKGROUND					





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Legend



Key Plan



Project Title

# SUNOL COMMUNITY SCHOOL

RESTROOMS UPGRADE
258 SUNOL STREET

SAN JOSE, CA 95126

SANTA CLARA COUNTY


OFFICE OF EDUCATION

No	No Revisions/Submissions					
1	DSA SUBMITTAL	06/28/2017				
2	DSA BACKCHECK SUBMITTAL	09/28/2017				

Drawing Title

#### SCHEDULE AND DETAILS

Regulatory Agency Approval

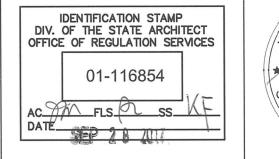

No. C-22312 Exp. 03-31-19

Architect Seal

File Number Drawing No

Application Number
Project No.
06307

06/27/2017

E2.0

PRIOR TO SUBMITTING PROPOSAL, BIDDER SHALL EXAMINE ALL GENERAL CONSTRUCTION DRAWINGS. VISIT CONSTRUCTION SITE AND ATTEND THE PRE-BID MEETING TO BE FAMILIAR WITH EXISTING CONDITIONS UNDER WHICH HE WILL HAVE TO OPERATE AND WHICH WILL IN ANYWAY AFFECT THE WORK UNDER THIS CONTRACT. NO SUBSEQUENT ALLOWANCE WILL BE MADE IN THIS CONNECTION IN BEHALF OF THE CONTRACTOR FOR ANY ERROR OR NEGLIGENCE ON HIS PART.

FIELD VERIFY TO CONFIRM ALL FIRE RATED CEILINGS AND WALLS. PROVIDE FIRE STOP SEALS PER UNIFORM BUILDING CODE FOR CONDUIT PENETRATION THROUGH FIRE RATED FLOORS, WALLS AND CEILINGS.

. ALL ELECTRICAL MATERIALS AND EQUIPMENT SHALL BE LISTED BY UNDERWRITER'S LABORATORIES AND BEAR THEIR LABEL.

CONDUIT ROUTING SHOWN IS ESSENTIALLY DIAGRAMMATIC. CONTRACTOR SHALL LAYOUT RUNS TO SUIT FIELD CONDITIONS AND THE COORDINATION REQUIREMENTS OF OTHER TRADES. ALL EXPOSED CONDUIT, BOXES, FITTINGS, SUPPORT, ETC. SHALL BE PAINTED TO MATCH ADJACENT SURFACES.

THE CONTRACTOR SHALL CONSULT THE ARCHITECTURAL MECHANICAL AND OTHER DRAWINGS RELATED TO THIS PROJECT FOR ADDITIONAL WORK TO BE PROVIDED.

THE OWNER RETAINS FIRST SALVAGE RIGHTS TO ALL EXISTING EQUIPMENT REMOVED UNDER THIS CONTRACT. THE ELECTRICAL CONTRACTOR SHALL CONSULT WITH THE OWNER FOR DISPOSITION OF THE EXISTING EQUIPMENT TO BE REMOVED BY HIM. THE CONTRACTOR SHALL INCLUDE IN HIS BID PROPOSAL ALL COSTS RELATED TO THE DISPOSAL OF EXISTING EQUIPMENT REMOVED UNDER THIS CONTRACT.

. ANY POWER SHUTDOWN SHALL BE COORDINATED WITH SCHOOL DISTRICT PROJECT MANAGER. A SHUTDOWN SCHEDULE SHALL BE PRESENTED TO SCHOOL DISTRICT FOR APPROVAL TWO WEEKS PRIOR TO COMMENCEMENT OF WORK. SHUTDOWN SHALL BE PERFORMED IN OVERTIME HOURS IF SO DIRECTED BY SCHOOL DISTRICT.

DEMOLITION WORK SHALL BE PROVIDED AS REQUIRED TO ACCOMPLISHED NEW WORK CALLED FOR AND AS NOTED. WORK SHALL BE PERFORMED CAREFULLY TO AVOID DAMAGE TO SURFACES, STRUCTURES, AND EQUIPMENT NOT BEING REMOVED. EXISTING EQUIPMENT AND/OR ELECTRICAL WIRING WHICH IS TO REMAIN, BUT HAS BEEN REMOVED TO FACILITATE THE INSTALLATION OF THE NEW EQUIPMENT, SHALL BE RESTORED TO ITS ORIGINAL OPERATING CONDITION.

10. BLANK COVERS SHALL BE INSTALLED WHEREVER DEVICE IS REMOVED AND OUTLET BOX REMAINS IN PLACE.

11. UNLESS OTHERWISE INDICATED, THE MINIMUM SIZE OF CONDUCTORS SHALL BE 12 AWG THWN STRANDED COPPER ONL.Y.

12. UNLESS OTHERWISE INDICATED, THE MINIMUM SIZE OF CONDUIT SHALL BE 3/4".

13. GREEN INSULATED GROUND CONDUCTORS SHALL BE INSTALLED IN ALL FEEDER AND BRANCH CIRCUIT WIRING.

14. PROVIDE LABELS ON ALL EQUIPMENT AND DEVICES. LABELS SHALL BE SELF-ADHESIVE PHENOLIC TYPE AND WHITE LETTER ON BLACK BACKGROUND, PROVIDE BRADY OR DYMO TYPE LABELS (CIRCUIT IDENTIFICATION) FOR ALL SWITCHES AND RECEPTACLES.

15. THE CONTRACTOR SHALL PROVIDE TYPEWRITTEN DIRECTORIES FOR ALL ELECTRICAL PANELS INVOLVED IN THIS PROJECT. THE PANEL DIRECTORIES SHALL REFLECT THE AS-BUILT CIRCUITS. ONE COPY OF THE SCHEDULE SHALL BE TAPED TO THE INSIDE OF THE PANEL DOOR, AND ONE COPY SHALL BE SUBMITTED TO THE ENGINEER AS AN "AS-BUILT" DRAWING.

16. ALL ELECTRICAL EQUIPMENT SHALL BE BRACED OR ANCHORED TO RESIST A SEISMIC FORCE ACTING IN ANY DIRECTION USING THE FOLLOWING CRITERIA:

a. THE TOTAL DESIGN LATERAL SEISMIC FORCE SHALL BE DETERMINED PER CALIFORNIA BUILDING CODE (CBC) 2013. FORCES SHALL BE APPLIED IN THE HORIZONTAL DIRECTIONS, WHICH RESULT IN THE MOST CRITICAL LOADING FOR DESIGN.

b. THE VALUE OF AD (COMPONENT AMPLIFICATION FACTOR), Rp (COMPONENT RESPONSE MODIFICATION FACTOR), Ca (SEISMIC COEFFICIENT) AND In (SEISMIC IMPORTANCE FACTOR) BE DETERMINED PER CALIFORNIA BUILDING CODE (CBC) 2013.

WHERE ANCHORAGE DETAILS ARE NOT SHOWN ON THE DRAWINGS, THE FIELD INSTALLATION SHALL BE SUBJECT TO THE APPROVAL OF THE FIELD REPRESENTATIVE OF THE DIVISION OF THE STATE ARCHITECT.

7. CERTAIN REMODELING OF ELECTRICAL FACILITIES WILL BE REQUIRED IN THE EXISTING BUILDING. THE DRAWINGS SHOWING LOCATION OF EQUIPMENT IN EXISTING AREAS ARE APPROXIMATE ONLY. THE CONTRACTOR SHALL CONCEAL ALL WORK; IF THIS NOT POSSIBLE, SURFACE RACEWAY SUCH AS WIREMOLD SHALL BE USED ONLY WITH THE APPROVAL OF THE ARCHITECT AND OWNER.

18. THE CONTRACTOR SHALL BE HELD FULLY RESPONSIBLE FOR THE PROPER RESTORATION OF ALL EXISTING SURFACES REQUIRING PATCHING, PLASTERING PAINTING AND/OR OTHER REPAIRS DUE TO THE INSTALLATION OF ELECTRICAL WORK UNDER THE TERMS OF THIS SPECIFICATION. CLOSE ALL OPENINGS, REPAIR ALL SURFACES, ETC., AS REQUIRED. THIS SHALL INCLUDE ALL WALLS. CEILINGS, ROOFS, PAVEMENT, PLANTERS, ETC.

19. OUTLETS MOUNTED ON WALL BACK TO BACK SHALL MAINTAIN A MINIMUM HORIZONTAL DISTANCE OF 24" OR BE SEPARATED BY A STUD.

20. ALL EXPOSED CONDUITS, BOXES AND CABINETS INSTALLED IN FINISHED AREAS SHALL BE PAINTED TO MATCH COLOR OF ADJACENT WALL OR CEILING.

21. THE CONTRACTOR SHALL MAINTAIN AT THE JOB SITE, AN UP TO DATE "AS BUILT" DRAWING SET. THE "AS BUILT" DRAWING SET SHALL REFLECT ALL APPROVED CHANGES TO THE DESIGN DRAWINGS. THE "AS BUILT" DRAWING SET SHALL BE KEPT CLEAN AND IN GOOD CONDITION AND SHALL BE TURNED OVER TO THE OWNER AT THE COMPLETION OF THE PROJECT. THESE DRAWINGS SHALL BE UPDATED DAILY AND BE CHECKED WEEKLY BY IOR. THE PROGRESS PAYMENT IS TIED TO THEIR COMPLETION.

22. UPON COMPLETION OF THE WORK, THE CONTRACTOR SHALL SCHEDULE AND PERFORM A COMPLETE FUNCTIONAL TEST TO DEMONSTRATE TO THE OWNER THAT THE NEW INSTALLATION IS OPERATING AS INTENDED. ANY DEFECTS OR DEFICIENCIES IN THE MATERIALS OR WORK SHALL CORRECTED IMMEDIATELY BY AND AT THE CONTRACTOR'S EXPENSE.

23. PROVIDE ACCESSIBLE PANEL FOR HEAT DETECTOR ABOVE CEILING WHERE REQUIRED.

# FIRE ALARM L E G E N D **WIRING** DESCRIPTION SYMBOL WIRING CONCEALED IN CEILING OR WALL \_\_\_\_ TO REMAIN, FUTURE \_\_\_\_\_ TO REMAIN, FUTURE

#### FIRE ALARM SYSTEM DESCRIPTION SYMBOL FIRE ALARM CONTROL PANEL AND ASSOCIATED LINE WEIGHT TOP TO BOTTOM= NEW, EXISTING COMPONENTS. PROVIDE 120V POWER AS REQUIRED OR AS INDICATED. WIRING CONCEALED IN FLOOR OR UNDER GRADE OR ROUTED IN CEILING SPACE OF FLOOR BELOW. ANN **ANNUNCIATOR** INE WEIGHT TOP TO BOTTOM= NEW, EXISTING SMOKE DETECTOR WIRING EXPOSED. LINE WEIGHT TOP TO BOTTOM= NEW, EXISTING TO REMAIN, FUTURE ABOVE CELING HEAT DETECTOR 44444 EXISTING ITEM TO BE REMOVED FIRE ALARM SYSTEM MANUAL PULL STATION, LOW VOLTAGE CABLE IN CONDUIT LV STROBE STROKES INDICATE QUANTITY OF #12 AWG. CONDUCTORS -----HORN/STROBE IF MORE THAN 3, UON. NOTE: WIRING STROKES FOR 20A BRANCH CIRCUITS ARE NOT SHOWN ON DRAWINGS. CONTRACTOR SHALL USE INFORMATION HORN - WEATHERPROOF IN PANEL AND BRANCH CIRCUIT SCHEDULES TO PROVIDE REQUIRED CIRCUITING. ALL SHARED NEUTRAL SHALL BE #10 U.O.N. \_\_\_\_ GROUND GROUND, ISOLATED HOT \_\_\_\_ NEUTRAL HOME RUN WIRING TO INDICATED DESTINATION, 3/4°C. MIN. OR AS OTHERWISE NOTED. CONTRACTOR SHALL USE CIRCUIT SIZES NOTED IN RESPECTIVE L1A - 1.3SCHEDULES AND INFORMATION IN THE FEEDER AND HD1A BRANCH CIRCUIT SCHEDULES. CONDUIT RUN TURNED UP THROUGH FLOOR OR CEILING. CORE & FIREPROOF AS REQUIRED. CONDUIT RUN TURNED DOWN THROUGH FLOOR OR CEILING. CORE & FIREPROOF AS REQUIRED. CONDUIT STUBBED OUT AT LOCATION SHOWN. PROVIDE INSULATED BUSHING & PULLROPE. RACEWAY STUBBED OUT FOR FUTURE CONTINUATION; CAP, MARK AND RECORD LOCATION. JUNCTION BOXES, WALL, CEILING AND FLUSH FLOOR MOUNTED. 4" SQ. BOX MIN., LARGER IF REQUIRED $\Theta$ $\Theta$ WIRING EXTENSION POINT - CONDUIT TO MC CABLE OR MANUFACTURED WIRING SYSTEM J-BOX ABOVE ACCESSIBLE CEILINGS AREAS, OR EXTEND CONDUIT & WIRE IN EXPOSED OR "HARD" CEILING AREAS. SHADED= ON ALT. POWER SOURCE (EMERG, UPS, ETC.) PULL BOX, MIN. SIZE PER NEC., UON. FLEXIBLE CONDUIT CONNECTION ~~~~ 777777 POWER CONNECTION TO DIV 15 FIRE/SMOKE DAMPER. REFER TO FSD CONNECTION DETAIL IF NOT SHOWN LOW VOLTAGE SYSTEM GROUND CONNECTION GROUND ROD CONNECTION GROUND ROD CONNECTION WITH TEST WELL BOX

### **APPLICABLE CODES**

LIGHTNING SYSTEM AIR TERMINAL

1. 2016 CALIFORNIA BUILDING STANDARDS ADMINISTRATIVE CODE (PART 1. TITLE 24, CCR)

2016 CALIFORNIA BUILDING CODE (CBC), VOLUMES 1 & 2 (PART 2, TITLE 24, CCR)

2016 CALIFORNIA ELECTRICAL CODE (PART 3, TITLE 24, CCR)

4. 2016 CALIFORNIA MECHANICAL CODE (PART 4, TITLE 24, CCR)

5. 2016 CALIFORNIA PLUMBING CODE (PART 5, TITLE 24, CCR)

6. 2016 CALIFORNIA ENERGY CODE (PART 6, TITLE 24, CCR)

2013 CALIFORNIA ELEVATOR SAFETY CONSTRUCTION CODE (PART 7, TITLE 24, CCR)

8. 2016 CALIFORNIA FIRE CODE (PART 9, TITLE 24, CCR)

2016 CALIFORNIA REFERENCE STANDARDS CODE (PART 12, TITLE 24, CCR)

10. NFPA 13. 2016 EDITION, THE INSTALLATION OF AUTOMATIC SPRINKLER SYSTEMS, AS AMENDED

NFPA 14, 2013 EDITION, THE INSTALLATION OF STANDPIPE, PRIVATE HYDRANT AND HOSE SYSTEMS

NFPA 24, 2016 EDITION, THE INSTALLATION OF PRIVATE

FIRE SERVICE MAINS AND THEIR APPURTENANCES

13. NFPA 72, 2016 EDITION, NATIONAL FIRE ALARM CODE,

### FIRE ALARM SCOPE OF WORK

THE INTENT OF THIS PROJECT IS TO PROVIDE A COMPLETE FIRE ALARM SYSTEM FOR THE RESTROOM UPGRADE

# FIRE ALARM SYSTEM GENERAL NOTE

THE FIRE DETECTION AND ALARM SYSTEM, UPON ACTIVATION OF AN INITIATING DEVICE, SHALL ALERT ALL OCCUPANTS AND SHALL TRANSMIT THE ALARM SIGNAL TO AN APPROVED SUPERVISING CENTRAL MONITORING STATION.

**ABBREVIATIONS** EXISTING TO REMAIN **FUTURE** EXISTING TO BE REMOVED EXISTING TO BE RELOCATED ABOVE COUNTER BACKSPLASH ACU AIR CONDITIONING UNIT AC ALTERNATING CURRENT A, AMP AMPERES AMPERE (RATED) FUSE OR CB FRAME AFF ABOVE FINISHED FLOOR **AFG** ABOVE FINISHED GRADE ALUMINUM (ALLOY) ALC AUTOMATIC LIGHTING CONTROL AS AMPERE (RATED) SWITCH CIRCUIT BRKR TRIP SETTING (AMPS) ATS AUTOMATIC TRANSFER SWITCH **AUTO** AUTOMATIC AUX **AUXILIARY** AWG AMERICAN WIRE GAUGE BELL (FIRE ALARM) BG BELOW GRADE CONDUIT (CIRCULAR RACEWAY) CAB CABINET CKT CIRCUIT CLG CEILING CO CONDUIT ONLY CU COPPER DC DIRECT CURRENT DIV DIVISION DPST DOUBLE POLE SINGLE THROW DWG DRAWING **ENCLOSURE** ELECTRICALLY OPERATED END OF LINE FIRE ALARM FIRE ALARM ANNUNCIATOR FIRE/SMOKE DAMPER

**ENCL** EO EOL

FA FAA **FSD** 

**GND** GROUND KEY OPERATED

MAX MAXIMUM MIN MINIMUM MTD MOUNTED MTR

NORMALLY CLOSED NEC NATIONAL ELECTRICAL CODE NORMALLY OPEN NO NTS

NOT TO SCALE NP NAMEPLATE OC ON CENTER

PANEL

Name of School:

Campus Address:

+,POS POSITIVE REQD RIGID NON-METALLIC CONDUIT (PVC) **RSE** REMOTE SIGNAL EXPANDER

S.A.D. SEE ARCHITECTURAL DRAWINGS

FIRE ALARM SYSTEM INFORMATION

258 SUNOL STREET, SAN JOSE, CA 95126

2016 California Building Code (CBC), Part 2, Title 24, C.C.R. (2015 IBC with 2016 California Amendments)

2016 California Fire Code (CFC), Part 9, Title 24, C.C.R. (2015 IFC with 2016 California Amendments)

2016 California Electric Code (CEC), Part 3, Title 24, C.C.R. (2014 NEC with 2016 California Amendments)

Group B (Office/Educational - Community College)

☐ Manual ☐ Automatic M Manual and Automatic

☐ In-building Fire Emergency/Voice Communication System ☐ Wide Area Mass Notification System

☐ Commercial Light & Power ☐ Emergency Generator

Secondary Power Supplies: 

Battery 

Emergency Generator 

Uninterruptible Power Supply

IDC's Class A Class B Class C Class D Class E Class X

SLC's Class A Sciass B Class C Class D Class E Class X

☐ Protected Premises 💥 Central Station

☐ Type IIIA ☐ Type IIIB ☐ Type IV ☐ Type VA ☐ Type VB

☐ In-building Mass Notification System

SUNOL COMMUNITY SCHOOL

NFPA 72, National Fire Alarm and Signaling Code, 2016 edition (CA Amended)

UL 521, Heat Detectors for Fire Protective Signaling Systems, 1999 edition

Building Construction Type(s): ☐ Type IA ☐ Type IB ☐ Type IIA ☐ Type IIB

Building Occupancy Classification(s): M Group E (Educational K-12)

UL 864, Control Units for Fire Protective Signaling Systems, 2014 edition

Building Designation(s): RESTROOMS UPGRADE

CCR Title-19, Public Safety, State Fire Marshal Regulation

UL 38, Manual Operating Signal Boxes, 2008 edition UL 268A, Smoke Detectors Duct Applications, 2008 edition

UL 464, Audible Signal Appliances, 2016 edition

System Installer (Specific Name):

Emergency Communication Systems

☐ One-way Emergency Communication System

Two-way Emergency Communication System

Distributed Recipient Mass Notification System

☐ In-building Emergency Communication System

System Classification:

TYP **TYPICAL** UNDERWRITERS LAB UNLESS OTHERWISE NOTED UNINTERRUPTIBLE POWER SUPPLY

# FIRE ALARM DRAWING LIST

FIRE ALARM COVER SHEET

FIRE ALARM SITE PLAN

FIRE ALARM PLAN AND RISER DIAGRAM

FIRE ALARM VOLTAGE DROP, BATTERY CALCULATION, LEGEND AND EQUIPMENT LIST

FIRE ALARM DETAILS

#### FIRE ALARM SYSTEM NOTES

ALL WIRING SHALL BE IN CONDUIT, U.O.N. MINIMUM CONDUIT SIZE SHALL BE 3/4"C.

PROVIDE AND INSTALL ALL CONDUIT, BOXES, CONDUCTORS, POWER SUPPLY, RELAYS, ZONE MODULES, CARDS, SWITCHES ETC. FOR A COMPLETE AND OPERABLE FIRE ALARM SYSTEM.

3. ALL REQUIREMENT OF CONTRACT SPECIFICATIONS AND DRAWING APPLY.

4. INSTALLATION SHALL CONFORM TO REQUIREMENTS OF APPLICABLE ELECTRICAL CODES.

5. TEE-TAP INSIDE BUILDING IN JUNCTION BOX. USE TERMINAL BLOCKS.

6. FIRE ALARM FIELD WIRING SPECIFICATIONS FOR ADDITIONAL INSTALLATION REQUIREMENTS.

7. 120VAC 60Hz INPUT POWER FOR FIRE ALARM CONTROLS SHALL BE A DEDICATED, LOCKING BREAKER PROPERLY LABELED "SOURCE FROM LINE OF MAIN DISCONNECT" OR "EMERGENCY POWER".

ALL WIRING INCLUDING SHIELDS MUST BE DRY AND FREE OF SHORTS AND GROUNDS.

120VAC IS NOT PERMITTED IN SAME CONDUIT WITH LOW VOLTAGE WIRING.

10. DO NOT APPLY POWER EXCEPT IN THE PRESENCE OF A FACTORY-TRAINED FIRE ALARM TECHNICAL REPRESENTATIVE.

11. THERE WILL BE NO CONDUIT ENTRY ALLOWED 18" OR LOWER ON THE SIDE PANELS OR THROUGH THE BOTTOM OF ALL CONTROL

12. ALL VISUAL ALARM IN EVERY ROOMS OR EXTERIOR WHERE OCCUR SHALL BE SYNCHRONIZED.

13. VISUAL DEVICE SHOULD NOT EXCEED 2 FLASHES PER SECOND AND SHOULD NOT BE SLOWER THAN 1 FLASH EVERY SECOND. THE DEVICE SHALL HAVE A PULSING LIGHT SOURCE THAT MEETS NFPA STROBE INTENSITY REQUIREMENTS WHICH VARIES WITH VIEWING CONDITIONS AND ROOM SIZES.

14. UNDERGROUND AND EXTERIOR CONDUITS TO HAVE WATER-TIGHT FITTINGS AND WIRES TO BE APPROVED FOR WET LOCATIONS.

15. AUDIBLE DEVICE(S) TO BE AT LEAST 15dBA ABOVE THE FOLIVALENT SOLÌND LEVEL BUT NOT LESS THAN 75dBA AT 10' OR MORE THAN 110dBA AT THE MINIMUM HEARING DISTANCE.

16. AUDIBLE DEVICE SHALL SOUND THE CALIFORNIA UNIFORM FIRE ALARM SIGNAL.

17. FINAL FIRE ALARM TEST SHALL BE MADE WITH THE DSA INSPECTOR OF RECORD (IOR). LOCAL FIRE AUTHORITY SHALL BE NOTIFIED OF DATA AND TIME OF FINAL FIRE ALARM TESTING

AND SHALL ASSIST/WITNESS SUCH TESTING WHEN ABLE. 18. FIRE ALARM CONTRACTOR SHALL PROVIDE A COMPLETED AND SIGNED" CERTIFICATE OF COMPLETION" AFTER COMPLETION OF

OPERATIONAL ACCEPTANCE TESTS. (NFPA 72 SEC. 7.8.2 &

19. PROVIDE TEMPORAL THREE DISTINCTIVE FIRE ALARM SOUND

(CFC SEC. 907.5.2.1.3 NFPA 72 SEC. 18.4.2.1)

20. POWER SERVICE SHALL BE ON A DEDICATED BRANCH CIRCUIT WITH RED MARKING AND IDENTIFIED PER NFPA SEC 10.6.5.2.2

21. WIRING AND MATERIALS SHALL BE PER CEC/NEC ART. 760.

22. A DOCUMENTATION CABINET SHALL BE INSTALLED PROXIMAL TO THE FACU. (NFPA 72, 7.7.2.1)

ALL RECORD DOCUMENTATION SHALL BE STORED IN THE DOCUMENT CABINET. (NFPA 72, 7.7.2.2)

24. THE DOCUMENT CABINET SHALL BE PROMINENTLY LABELED SYSTEM RECORD DOCUMENT (NFPA 72, 7.7.2.4.)

### NFPA 72 REQUIREMENTS

. POWER SERVICE SHALL BE ON A DEDICATED BRANCH CIRCUIT WITH A RED MARKING AND IDENTFIED PER (NFPA 72 SEC. 10.6.5.2.2)

2. PROVIDE TEMPORAL— THREE DISTINCTIVE FIRE ALARM SOUND, (CFC SEC. 907.5.2.1.3, NFPA 72 SEC. 18.4.2.1).

3. AUDIBLE FIRE ALARM SOUND LEVEL SHALL BE AT LEAST 15 DBA ABOVE THE AVERAGE AMBIENT SOUND LEVEL IN ALL OCCUPINABLE AREAS, (NFPA 72 SEC. 18.4.3.1). (IE. CLASSROOM AVERAGE AMBIENT ROOM NOISE IS 45 DBA PLUS 15 DBA EQUALS = 60 DBA MINIMUM ALARM TONE REQUIRED)

4. STROBES SHALL FLASH AT A RATE OF NOT EXCEEDING TWO FLASHES PER SECOND NOR BELESS THAN ONE FLASH EVERY SECOND, (2016 NFPA 72 SEC. 18.5.3.1).

5. FINAL FIRE ALARM TEST SHALL BE MADE WITH THE DSA INSPECTOR OF RECORD (IOR). LOCAL FIRE AUTHORITY SHALL BE NOTIFIED OF THE DATE AND TIME OF FINAL FIRE ALARM TESTING AND SHALL ASSIST/WITNESS SUCH TESTING WHEN ABLE.

6. FIRE ALARM CONTRACTOR SHALL PROVIDE A "RECORD OF COMPLETION" TO THE INSPECTOR OF RECORD (IOR)/DSA AFTER COMPLETION OF OPERATIONAL ACCEPTANCE TESTS, (2016 NFPA 72 SEC. 7.8.2 AND FIGURE 7.8.2).

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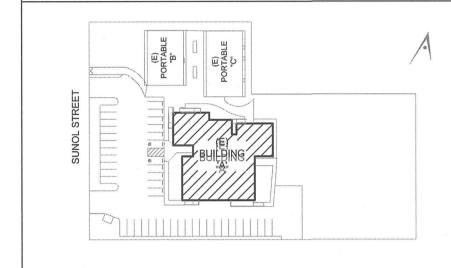
Consultant Seal



Legend



Key Plan



# SUNOL COMMUNITY SCHOOL

RESTROOMS UPGRADE 258 SUNOL STREET

SAN JOSE, CA 95126

SANTA CLARA COUNTY OFFICE OF EDUCATION

No	Revisions/Submissions	Date
1	DSA SUBMITTAL	06/28/2017
2	DSA BACKCHECK SUBMITTAL	09/28/2017

**Drawing Title** 

FIRE ALARM COVER SHEET

01-116854

Regulatory Agency Approval


IDENTIFICATION STAMP DIV. OF THE STATE ARCHITECT OFFICE OF REGULATION SERVICES No. C-22312 \O\_\ Exp. 03-31-19 AC\_\_\_FLS\_\_SS\_\_ DATE\_\_\_\$\frac{45p}{2}\frac{9}{2}\frac{9}{2}\frac{9}{2}\frac{1} C. OF CALIFOR


Architect Seal

File Number Drawing No

**Application Number** Project No. 06307

FA0.1

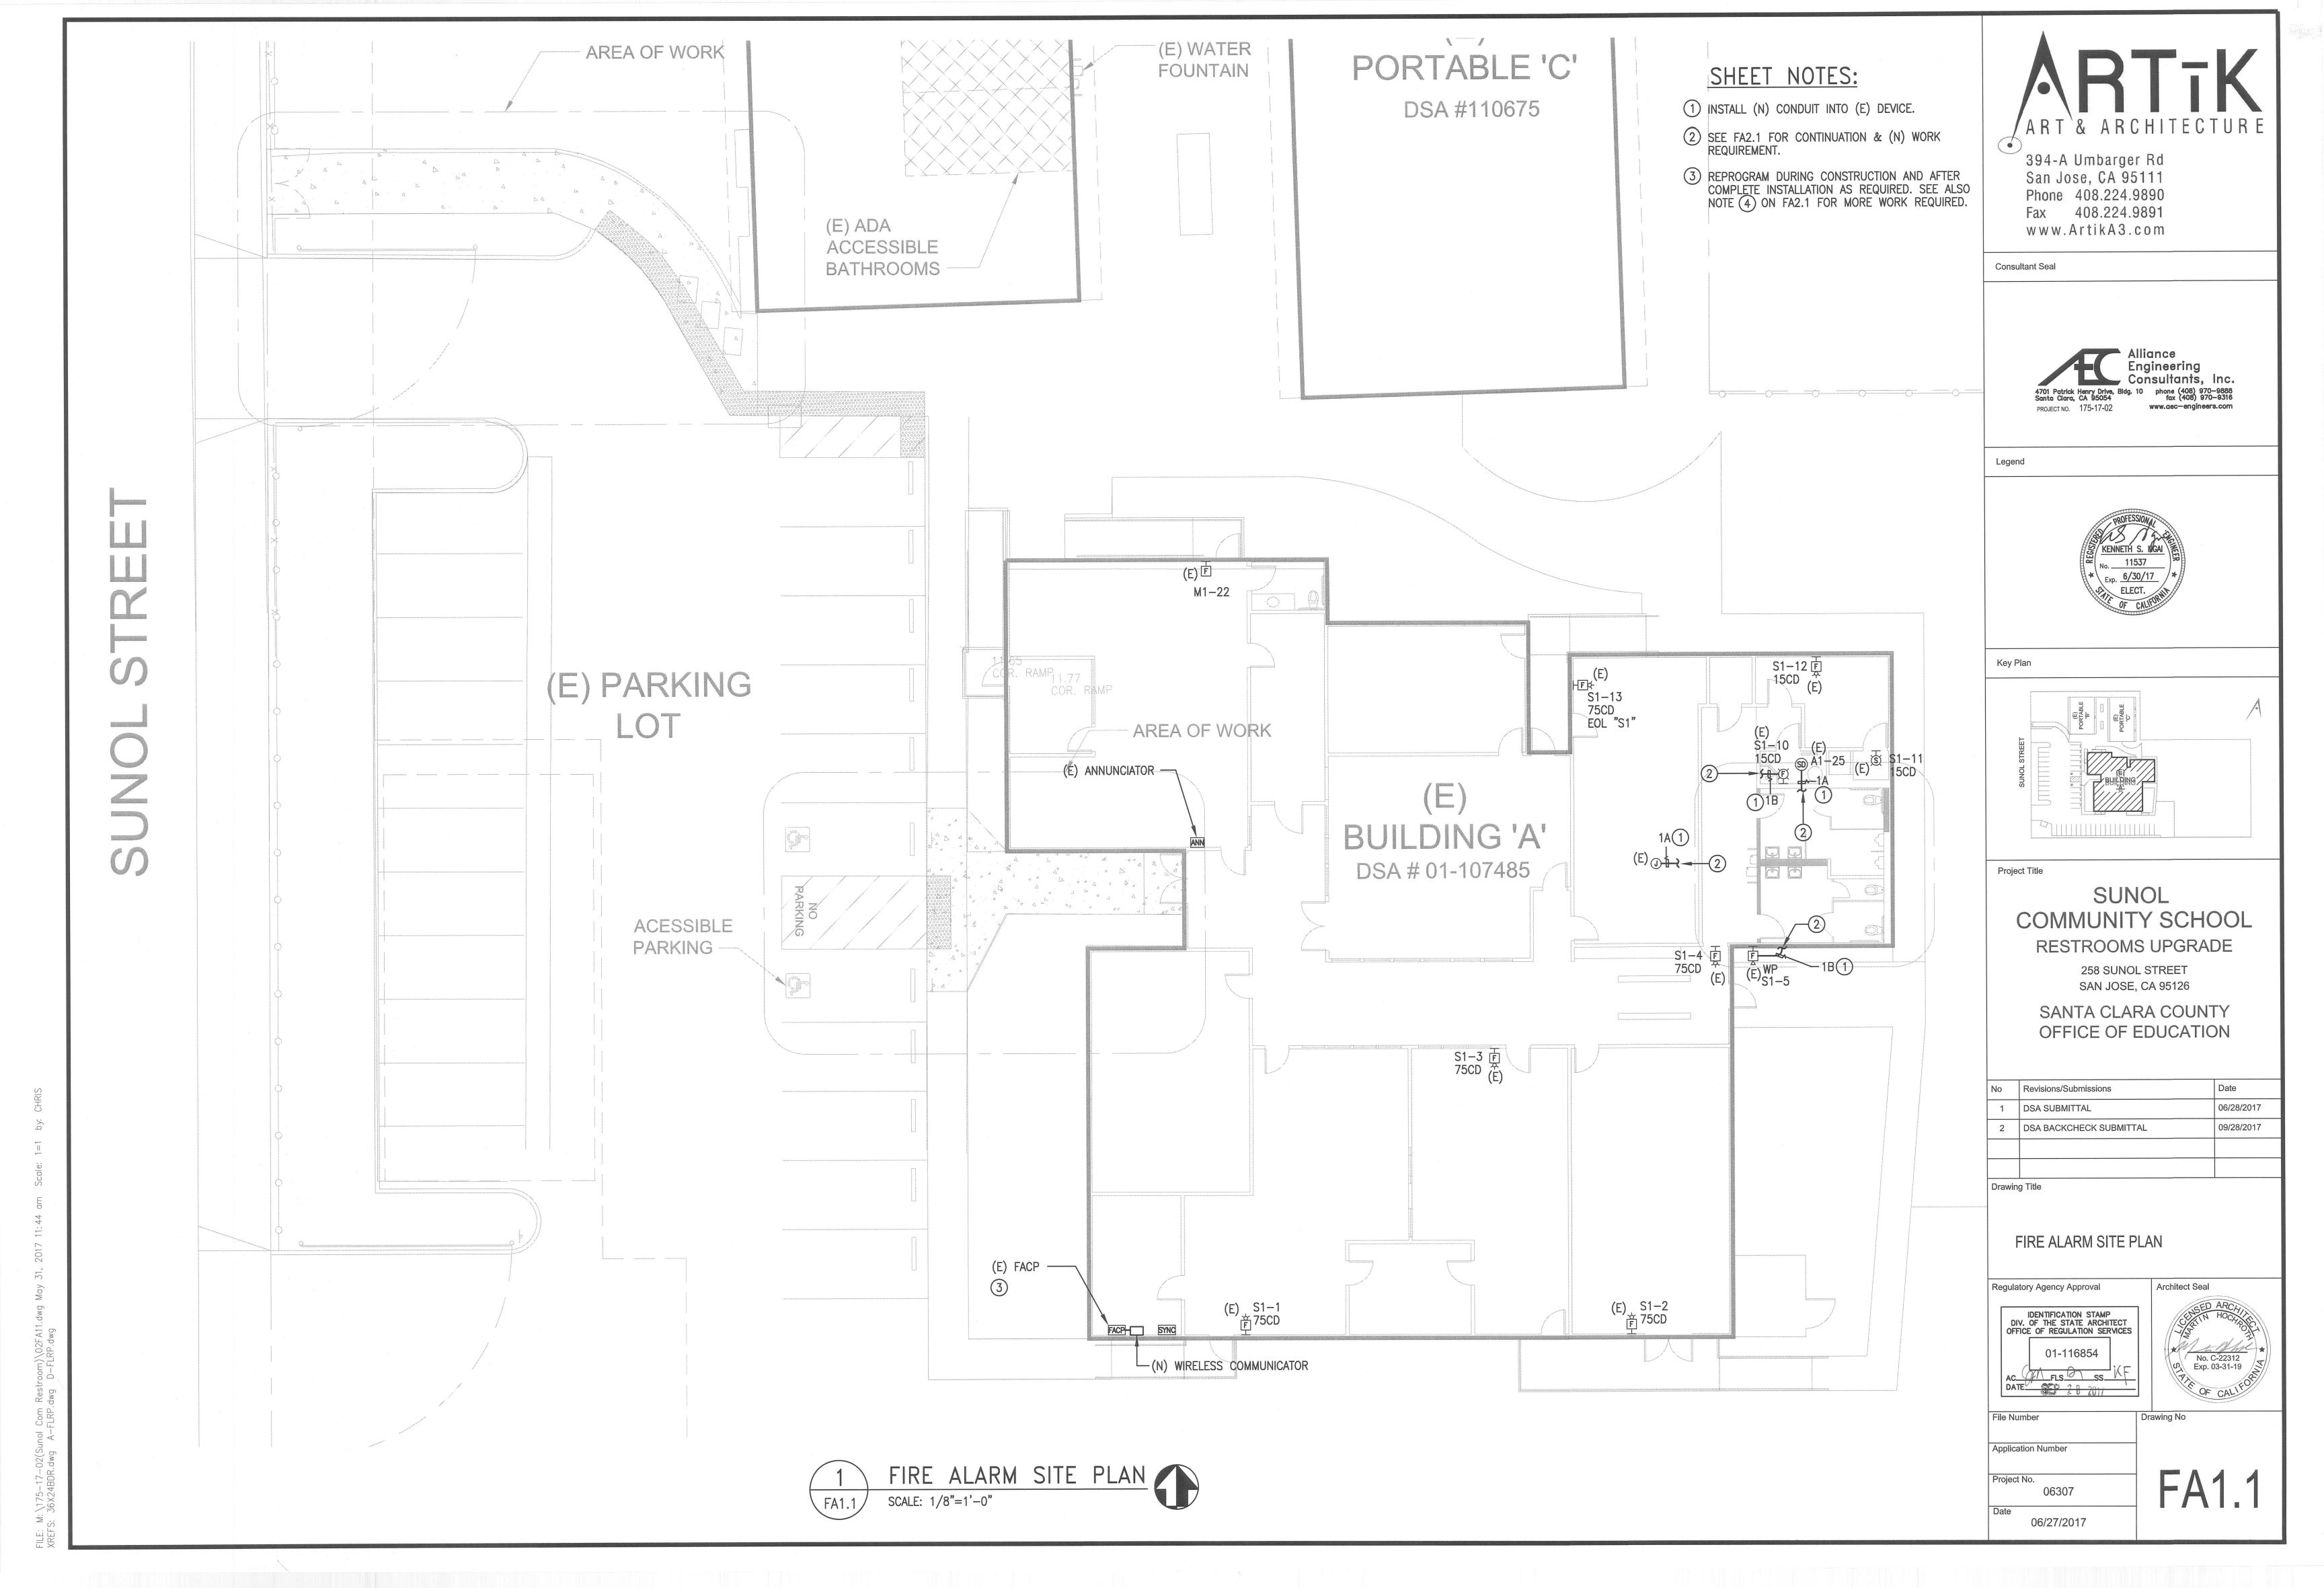

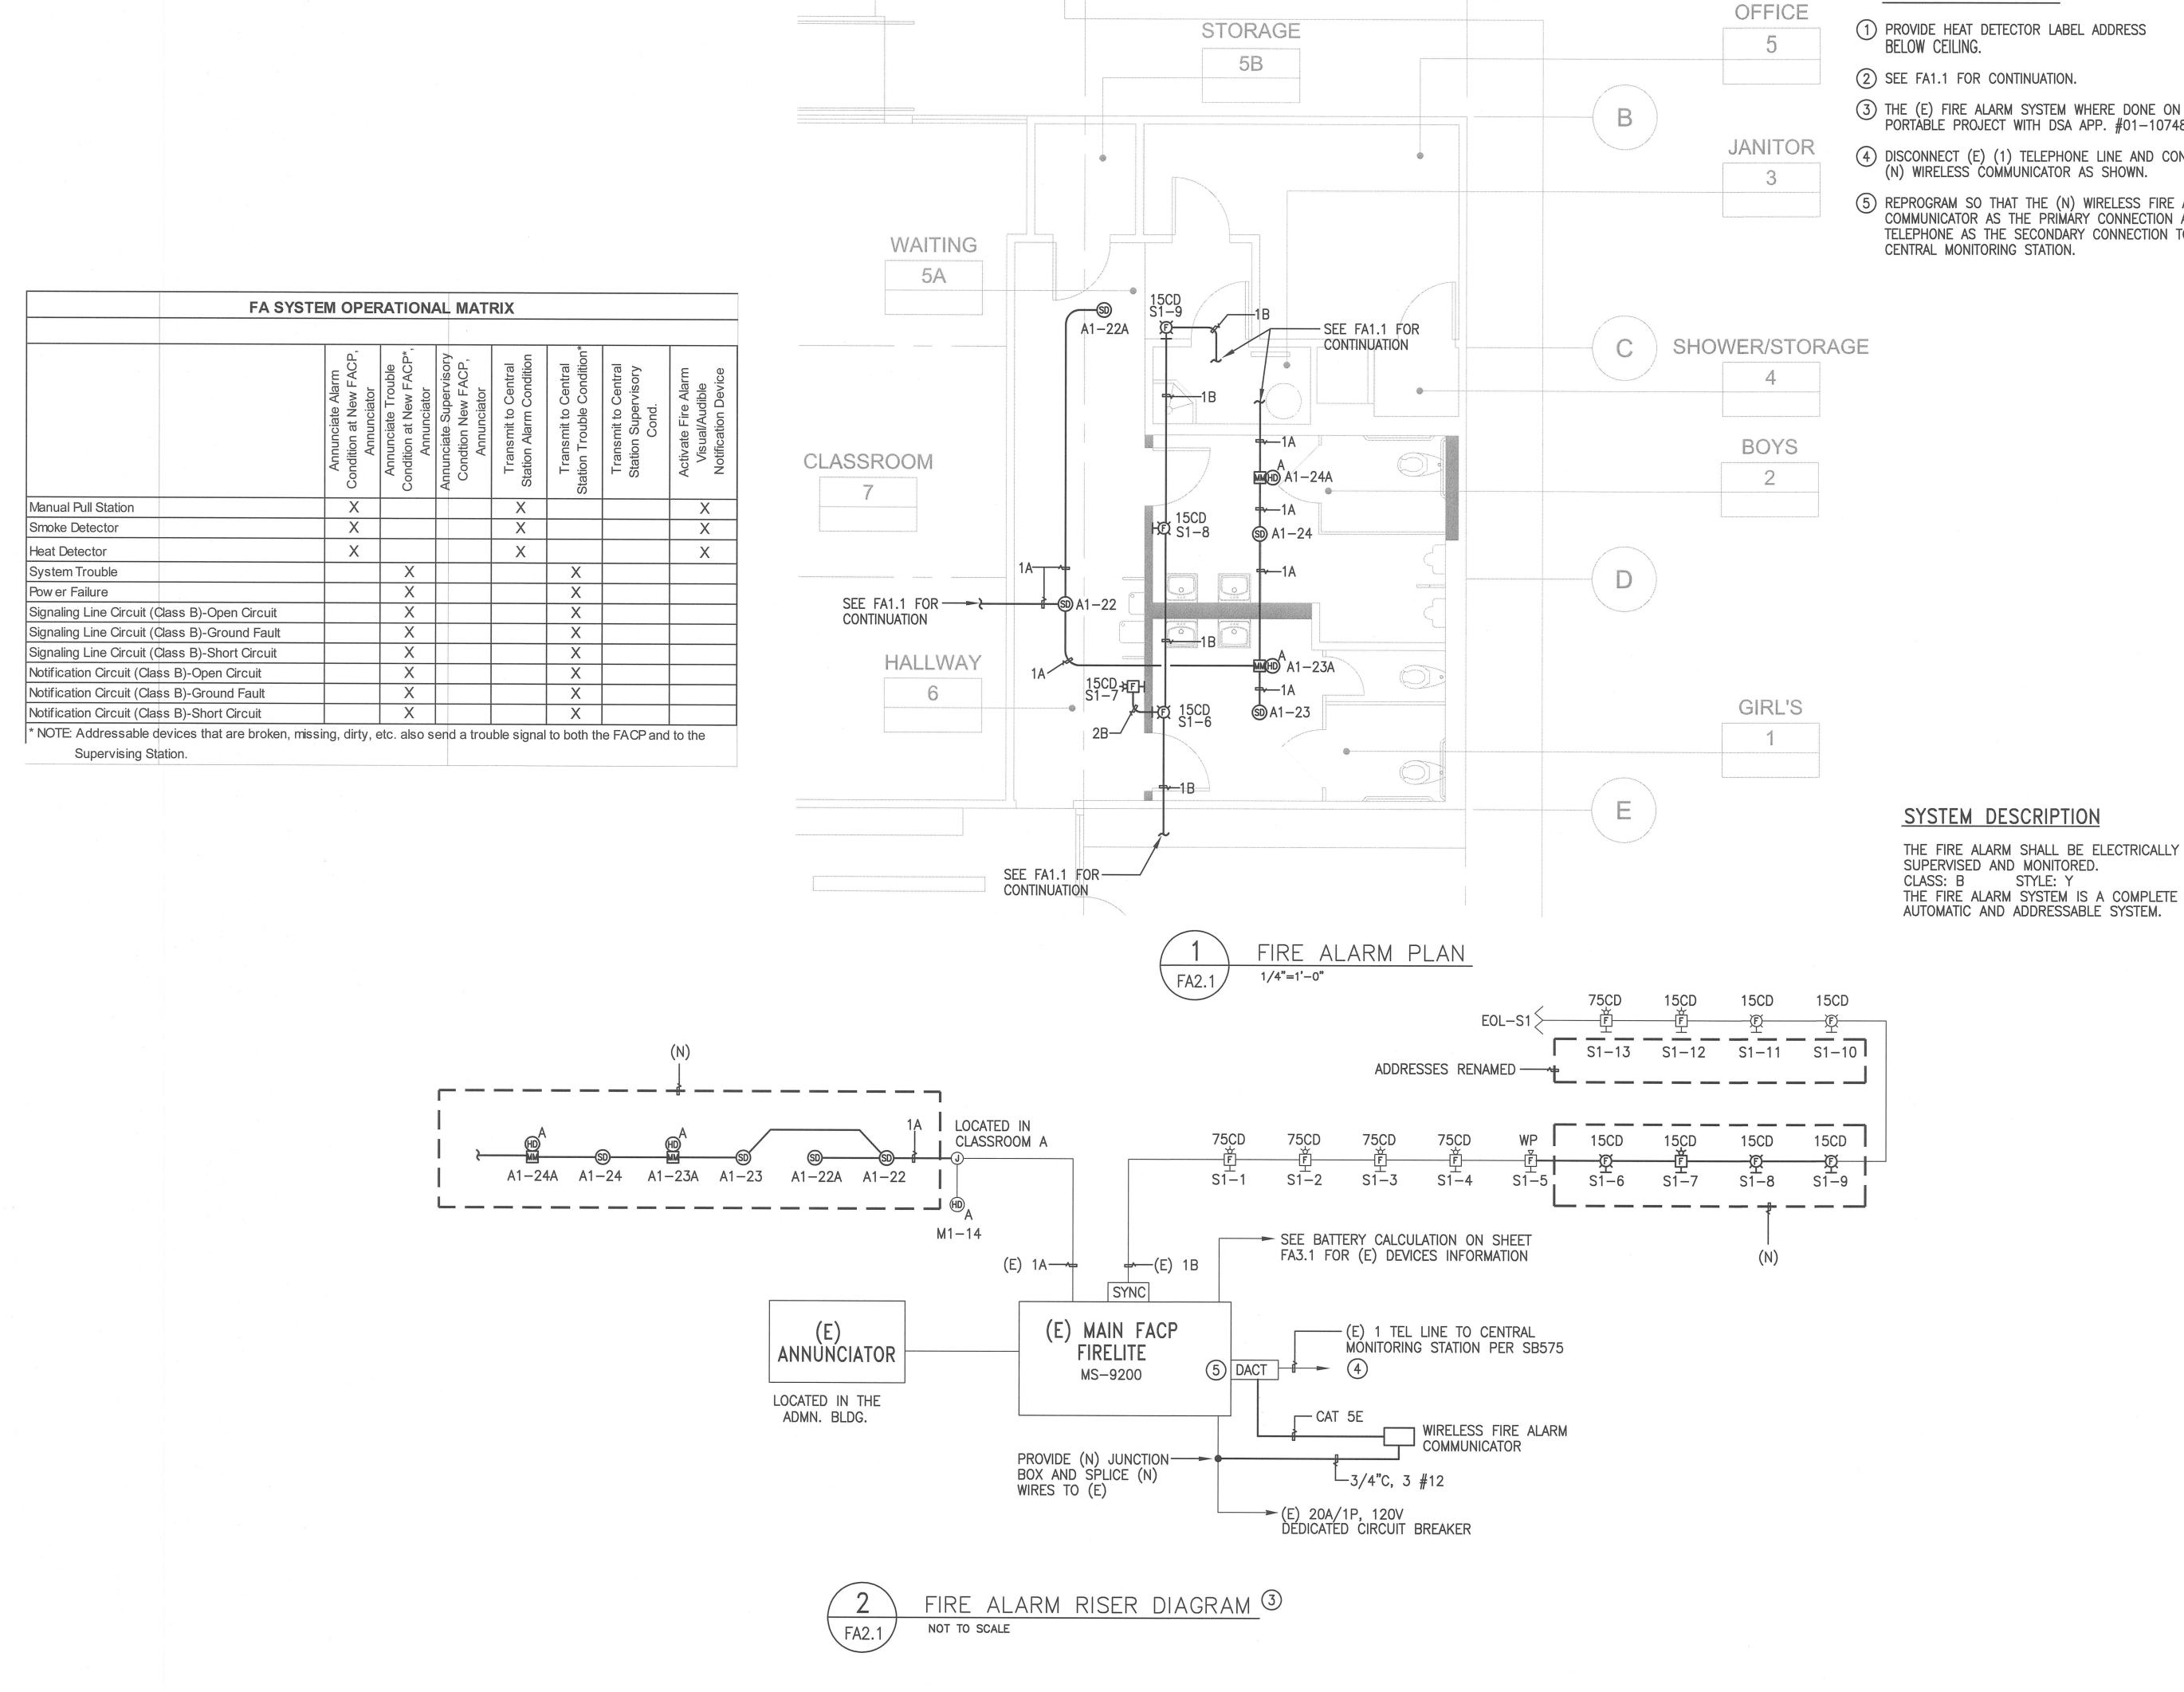

# **SHEET NOTES:**

- (1) PROVIDE HEAT DETECTOR LABEL ADDRESS BELOW CEILING.
- (2) SEE FA1.1 FOR CONTINUATION.
- THE (E) FIRE ALARM SYSTEM WHERE DONE ON PORTABLE PROJECT WITH DSA APP. #01-107485.
- 4 DISCONNECT (E) (1) TELEPHONE LINE AND CONNECT (N) WIRELESS COMMUNICATOR AS SHOWN.
- (5) REPROGRAM SO THAT THE (N) WIRELESS FIRE ALARM COMMUNICATOR AS THE PRIMARY CONNECTION AND TELEPHONE AS THE SECONDARY CONNECTION TO CENTRAL MONITORING STATION.

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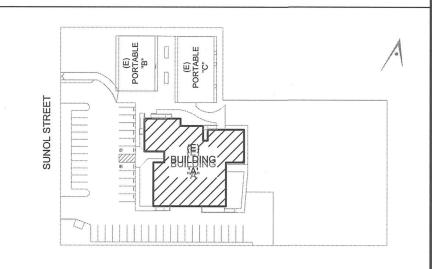
Consultant Seal



Legend



Key Plan



Project Title

# SUNOL COMMUNITY SCHOOL RESTROOMS UPGRADE

258 SUNOL STREET SAN JOSE, CA 95126

SANTA CLARA COUNTY OFFICE OF EDUCATION

No	No Revisions/Submissions							
1	DSA SUBMITTAL	06/28/2017						
2	DSA BACKCHECK SUBMITTAL	09/28/2017						
		-						

FIRE ALARM PLAN AND RISER DIAGRAM



No. C-22312 Exp. 03-31-19

Architect Seal

Drawing No

File Number

Project No.

Drawing Title

**Application Number** 

						Standby Curren	t (A)	Alarm Current	(A)
(E) CPU						0.080	A	0.168	<del>()</del>
		X	Standby	0.040	Α	0.040	A		•
(E) UDACT, Alarm Communicator	1	-	Alarm	0.100	Α			0.100	
		X	Standby	0.000	Α	0.000	А		-
		_	Alarm	0.000	Α		- 1	0.000	
								0.000	
Auxiliary Devices Catalog#	Qty								
		Х	Standby	0.00036	А	0.0122	А		
(E) SD-355 Addressable smoke detector	34	X	Alarm	0.06500	Α			2.2100	
		X	Standby	0.00036	Α	0.0014	А		
(N) SD-355 Addressable smoke detector	4	X	Alarm	0.06500	Α			0.2600	
		X	Standby	0.00030	Α	0.0006	А		
(N) FST-851 Addressable Heat detector	2	X	Alarm	0.06500	А			0.1300	
		×	Standby	0.000375	Α	0.0259	A		•
(E) F1GT Pull Station	69	X	Alarm	0.000375	А			0.0259	
		X	Standby	0.000375	Α	0.0008	A		•
(N) MVF-301 Monitor Module	2	X	Alarm	0.051000	А			0.102	
		X	Standby	0.000750	A	0.0000	A		-
(N) I300 Isolator Module	0	X	Alarm	0.057000	Α			0.000	
		×	Standby	0.000400	A	0.0000	A	0.000	•
(N) CIVF-300 Control Module	0	X	Alarm	0.065000	Α			0.000	
		X	Standby	0.000000	Α	0.0000	A		•
		X	Alarm	0.000000	Α			0.000	
Notification Devices Catalog#	Qty								
ST-24-15cd Strobe	0	×	Alarm	0.057	А			0.000	
ST-30cd Strobe	0	x	Alarm	0.085	Α			0.000	
ST-75cd Strobe	0	X	Alarm	0.135	A			0.000	
ST-110cd Strobe	0	X	Alarm	0.182	Α			0.000	
HS-15cd Horn/Strobe	0	X	Alarm	0.082	A			0.000	
HS-30cd Horn/Strobe	0	X	Alarm	0.102	A			0.000	
HS-75cd Horn/Strobe	0	X	Alarm	0.148	Α			0.000	
HS-110cd Horn/Strobe	0	X	Alarm	0.197	Α			0.000	
AH-24WPWeatherproof Horn	0	X	Alarm	0.080	А			0.000	
NH-24R Horn, Low	0	X	Alarm	0.018	Α			0.000	
DSM-24R	0	X	Alarm	0.055	Α			0.000	
		X	Alarm		Α			0.000	
Total Standby Current				***************************************		0.161	A		
Total Alarm Current			, .					2.996	
Hours of Standby required by NFPA 72 Sta	andards	, (4,	24 or 60)	X	24	HOURS			
Total A.H required for standby:							T	3.86	A
				X					
	Standard	s		X	5min.	(0.0833 Hours	)		
5 Mnute of Alarmoperation per NFPA 72 S				:	A THE RESTRICTION OF THE PARTY		Т	0.250	A
5 Mnute of Alarmoperation per NFPA 72 S  Total A.H required for Alarm:							1	0.200	
				3				0.200	II A CONTENT OF THE PARTY OF TH
	nt:							4.11	Al-
Total A.H required for Alarm:		sired	performance				X		Al

Not	es

SIGCKT#---

- An additional multiplier is included to compensate for the higher discharge rate in alarm Battery capacity decreases with age
- A 4-year old battery can lose up to 50% of its capacity. Compensations should be made to allow for this loss.
- The Standby current + Alarm current must never exceed 4.66 Amps.
- (E) Battery set is 12 AH

#### VOLTAGE DROP (VD) CALCULATION


PROJ. NAME---- ALEXANDER ROSE E.S.


DEVICE#	1st	2nd	3rd	4th	5th	6th	7th	8th	9th	10th	11th	12th	13th
GAUGE WIRE	14	14	14	14	14	14	14	14	14	14	14	14	14
DISTANCE (FT)	30	60	60	60	20	30	30	30	30	20	30	30	40
AMPS@DEVICE	0.148	0.148	0.148	0.148	0.08	0.057	0.082	0.057	0.057	0.057	0.057	0.082	0.148
AMPS DEVELOPED	1.269	1.121	0.973	0.825	0.677	0.597	0.54	0.458	0.401	0.344	0.287	0.23	0.148
VOLT. DROP	0.1918728	0.3389904	0.2942352	0.24948	0.0682416	0.0902664	0.081648	0.0692496	0.0606312	0.0346752	0.0433944	0.034776	0.0298368


SIGNAL CIRCUIT# #REF! TOTAL CKT V.D.= OKT VOLTAGE= **VOLTAGE AT** FINAL DEVICE= 18.812702 %VOLTAGE DROP= 7.7808706

EQUIPMENT LIST								
MANUFACTURER	MODEL	DESCRIPTION	CSFM NUMBER					
Firelite	MS-9200	(E) Fire Alarm Control Panel	DISCONTINUED					
AES	7788F	Wireless Fire Alarm Monitoring	7300-1516:0108					
System Sensor	5602	High, Fixed Temperature Heat Detector	7272-1653:0167					
Firelite	B210LP	Base, Detector, Addressable	7272-0075:0194					
Firelite	SD-355	Smoke Detector Head, Photoelectric, Analog	7272-0075:0194					
Firelite	CMF-300	Control Module	7300-0075:0185					
Firelite	MMF-301	Monitor Module	7300-0075:0185					
Wheelock	HS	Horn Strobe	7125-0785:0168					
Wheelock	ST	Strobe	7125-0785:0168					
Wheelock	AH-24WP-R	Horn, Weatherproof	7125-0785:0131					
Wheelock	WBB-R	Back Box, Exterior						
West Penn	D990	Cable, 1 PR 16 AWG Twisted pair Type FPL	7161-0859:0101					
West Penn	994S	Cable, 1 PR 14 AWG Twisted pair Type FPL	7161-0859:0101					
	THHN/THWN	#12 SOLID, BLACK						
	THHN/THWN	#12 SOLID, RED						

F	FIRE ALARM WIRI	NG LEGEND
SYMBOL	WIRE TYPE	USED ON
	2-CONDUCTOR, #16 TWISTED PAIR UNSHIELDED (D990)	ADDRESSABLE ALARM INITIATING DEVICES:  - SMOKE DETECTORS  - INTERFACE MODULES  - PULL STATION
	2-CONDUCTOR, #16 TWISTED PAIR UNSHIELDED (AQ225)	ADDRESSABLE ALARM INITIATING DEVICES:  - SMOKE DETECTORS  - INTERFACE MODULES  - PULL STATION
B B	2-CONDUCTOR, #14 AWG UNSHIELDED (994S)	AUDIO/VISUAL FROM NAC INDICATING DEVICES:  — (SYNC HORN/STROBE CIRCUITS)
	2-CONDUCTOR, #12 AWG SOLID, THWN (GROUNDED WIRE)	120 VAC POWER WIRING TO:  - F.A. CONTROL PANEL POWER SUPPLY PANEL

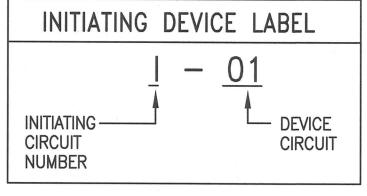

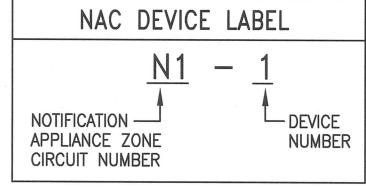

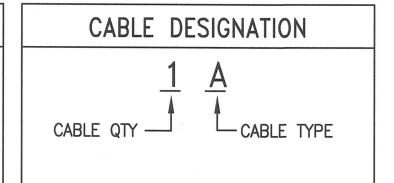



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Consultant Seal



Legend



Key Plan



Project Title

# SUNOL **COMMUNITY SCHOOL**

RESTROOMS UPGRADE 258 SUNOL STREET SAN JOSE, CA 95126


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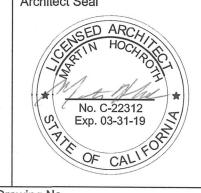
No	Revisions/Submissions	Date					
1	DSA SUBMITTAL	06/28/2017					
2	DSA BACKCHECK SUBMITTAL	09/28/2017					

Drawing Title

FIRE ALARM VOLTAGE DROP, BATTERY CALCULATION, LEGEND AND EQUIPMENT LIST

Regulatory Agency Approval




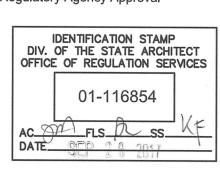


File Number

Drawing No

Application Number

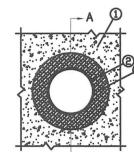

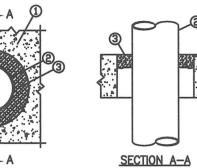

1. FLOOR OR WALL ASSEMBLY — MIN 4-1/2 IN. THICK LIGHTWEIGHT OR NORMAL WEIGHT CONCRETE. WALL MAY ALSO BE CONSTRUCTED OF ANY UL CLASSIFIED CONCRETE BLOCKS. MAX THROUGH OPENING SIZE IS 12.4 SQ. IN.


SEE CONCRETE BLOCKS (CAZT) CATEGORY IN FIRE RESISTANCE DIRECTORY FOR NAMES OF MANUFACTURERS.

- 2. PIPE OR CONDUIT NOM. 10 IN. DIA. (OR SMALLER) SCHEDULE 10 (OR HEAVIER) STEEL PIPE, NOM 6 IN. DIA. (OR SMALLER) RIGID STEEL CONDUIT, NOM 4 IN. DIA. (OR SMALLER) STEEL EMT OR NOM 3 IN. DIA. (OR SMALLER). TYPE L (OR HEAVIER) COPPER PIPE. MAX ONE PIPE OR CONDUIT PER THROUGH OPENING. MAX ANNULAR SPACE BETWEEEN PIPE OR CONDUIT AND EDGE OF OPENING IS 3/4 IN. MIN ANULAR SPACE BETWEEN PIPE OR CONDUIT AND EDGE OF OPENING IS 0 IN. (POINT CONTACT). PIIPE OR CONDUIT TO BE RIGIDLY SUPPORTED ON BOTH SIDES OF FLOOR OR WALL ASSEMBLY.
- 3. FILL VOID OR CAVITY MATERIALS PUTTY—MOLDABLE PUTTY MATERIAL KNEEDED BY HAND AND APPLIED TO FILL ANNULAR SPACE TO A MIN DEPTH OF 1 IN FLUSH WITH TOP SURFACE OF FLOOR. IN WALL ASSEMBLIES, REQUIRED PUTTTY THICKNESS TO BE INSTALLED SYMMETRICALLY ON BOTH SIDES OF WALL.


  MINNESOTA MINING & MFG. CO.— MPS—2+.

SYSTEM NO. CAJ1044
(Formerly System No. 319)

T RATING - 0 HR
L RATING AT AMBIENT - 2 CFM/SQ FT (SEE ITEM 4)
L RATING AT 400 F - LESS THAN 1 CFM/SQ FT (SEE ITEM 4)

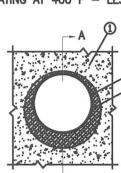

BEARING THE UL CLASSIFICATION MARKING.

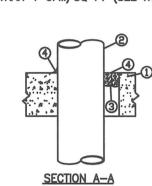

- 1. FLOOR WALL ASSEMBLY-LIGHTWEIGHT OR NORMAL WEIGHT (100-150 PCF) CONCRETE. EXCEPT AS NOTED IN TABLE UNDER ITEM 4, MIN THICKNESS OF SOLID CONCRETE FLOOR OR WALL ASSEMBLY IS 4-1/2 IN. FLOOR MAY ALSO BE CONSTRUCTED OF ANY MIN 6 IN. THICK UL CLASSIFIED HOLLOW-CORE. PRECOAT CONCRETE UNITS. WHEN FLOOR IS CONSTRUCTED OF HOLLOW-CORE PRECOAT CONCETE UNITS, PACKING MATERIALS (ITEM 3) AND CAULK FILL MATERIAL (ITEM 4) TO BE INSTALLED SYMETRYCALLY ON BOTH SIDES OF THE FLOOR, FLUSH WITH FLOOR SURFACE. WALL ASSEMBLY MAY ALSO BE CONSTRUCTED OF CLASSIFIED CONCRETE BLOCKS. MAX DIA. OF OPENING IS 32 IN.

  SEE CONCTRETE BLOCKS (CAZT) AND PRECAST CONCRETE UNITS (CFTV) CATEGORY IN THE FIRE RESISTANCE DIRECTORY FOR NAMES OF MANUFACTURER
- 1A. STEEL SLEVE (OPTIONAL NOT SHOWN) NOM 16 IN. (OR SMALLER) SCHEDULE 10 (ORHEAVIER) STEEL SLEEVE CAST OR GROUTED INTO FLOOR OR WALL ASSEMBLY. SLEEVE MAY EXTEND A MAX OF 2 IN. ABOVE TOP FLOOR OR BEYOND EITHER SURFACE OF WALL.
- 2. PIPE OR CONDUIT NOM 30 IN.DIA. (OR SMALLER) CAST IRON OR SCHEDULE 10 (OR HEAVIER) STEEL PIPE, NOM 6 IN. DIA. (OR SMALLER) STEEL CONDUIT, NOM 3 IN. DIA. (OR SMALLER) TYPE L (OR HEAVIER) COPPER TUBE OR NOM 4 IN. DIA. (OR SMALLER) STEEL ELECTRICAL METALIC TUBING. MAX ANNU; AR SPACE BETWEEN PIPE OR CONDUIT AND EDGE OF THROUGH OPENING NOT TO EXCEED 2 IM. MIN ANNULAR SPACE BETWEEN PIPE OR CONDUIT AND EDGE OF THROUGH OPENING IS 0 IN. (POINT CONTACT). PIPE OR CONDUIT TO BE RIGIDLY SUPPORTED ON BOTH SIDE OF FLOOR OR WALL ASSEMBLY.
- 3. PACKING MATERIAL POLYETHYLENE BACKER ROD OR NOM 1 IN. THICKNESS OF THIGHTLY—PACKRD MINERAL WOOL BATT OR GLASS FIBER INSULATION FIRMLY PACKED INTO OPENING AS A PERMANENT FORM. PACKING MATERIAL TO BE RECESSED FROM TOP SURFACE OF FLOOR OF FROM BOTH SURFACES OF WALL AS REQUIRED TO ACCOMODATE THE REQUIRED THICKNESS OF CAULK FILL MATERIAL (ITEM 4).
- 4. FILL, VOID OR CAVITY MATERIAL CAULK APPLIED TO FILL THE ANNULAR SPACE FLUSH WITH TOP SURFACE OF FLOOR. IN WALL ASSEMBLIES, REQUIRED CAULK THICKNESS TO BE INSTALLED SYMMETRICALLY ON BOTH SIDES OF WALL, FLUSH WITH WALL SURFACE. THE HOURLY F RATING AND THE MIN REQUIRED CAULK THICKNESS ARE DEPENDENT UPON A NUMBER OF PARAMETERS, AS SHOWN ON THE FOLLOWING TABLE.


MIN FLOOR OR WALL	NOM PIPE TUBE OR CONDUIT	MAX ANNULAR	MAX CAULK	F
THKNS, IN	DIA. IN.	SPACE, IN	THKNS, IN	RATING, HR
2-1/2	1/2-12	1-3/8	1/2	2
2-1/2	1/2-12	2-7/8	1	2
4-1/2	1/2-6	1-3/8	1/4(a)	2
4-1/2	1/2-12	1-1/4	1/2	3
4-1/2	1/2-20	2	1′	3
4-1/2	22-30	2	ż	3
5-1/2	1/2-6	1-3/8	1(b)	4
0 ./-	.,_ 0	. 0,0	. (5)	•

(a) MIN 2 IN THICKNESS OF MINERAL—WOOL BATT INSULATION REQUIRED IN ANNULAR SPACE.
(b) MIN 1 IN. THICKNESS OF MINERAL—WOOL BATT INSULATION REQUIRED IN ANNULAR SPACE ON BOTH SIDES OF FLOOR OR WALL ASSEMBLY. MIN 1IN. THICKNESS OF CAULK TO BE INSTALLED FLUSH WITH EACH SURFACE FLOOR OR WALL ASSEMBLY.

MINNESOTA MINING & MANUKACTURING CO - TYPES CP-25 WB, CP-25 WB+.


(NOTE: L RATING AND OR USE OF OPTIONAL SLEEVE APPLY ONLY WHEN TYPE CP-25WB+ CAULK IS USED).

SYSTEM NO. WL1001 (Formerly System No. 147) F RATING - 1 & 2 HOUR T RATING - 0, 1, 1-1/2 & 2 HOUR

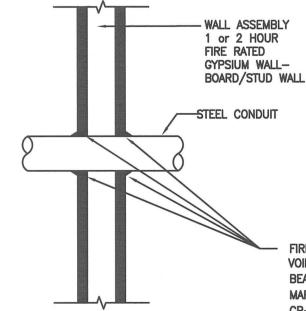



FIRESTOP SYSTEM FILL,
VOID OR CAVITY MATERIALS
BEARING UL CLASSIFICATION
MARKING 3M TYPE CP-25 S/L


- SEAL ALL PENETRATIONS IN ACCORDANCE WITH APPLICABLE CODES TO PRESERVE ORIGINAL FIRE HOUR RESISTANCE OF WALLS, FLOORS OR CEILINGS. USE UL DIRECTOY ASSEMBLY NOS. 49 & 328, AS APPLICABLE FOR ALL FIRE WALL PENETRATIONS.
- 2. AT FIRE SEPARATION WALLS, WRAP CONDUIT WITH 3M CONDUIT WRAP F3-195 TO WITHIN 1/4" OF OPENING; FILL THE GAP AND COVER EDGE OF WRAP WITH 3M-CP25 CAULK AND/OR #303 PUTTY.

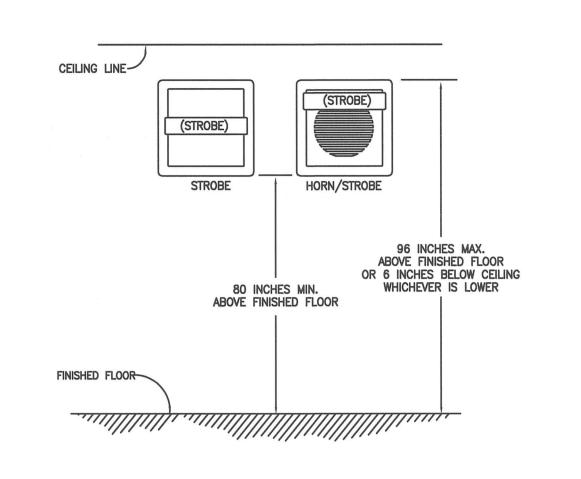

TYPICAL MOUNTING ELEVATION DETAIL OF STROBE & HORN/STROBE

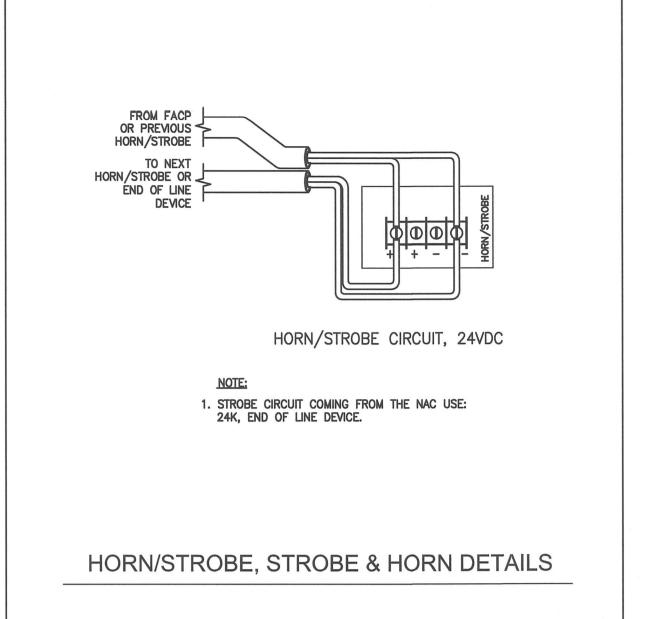

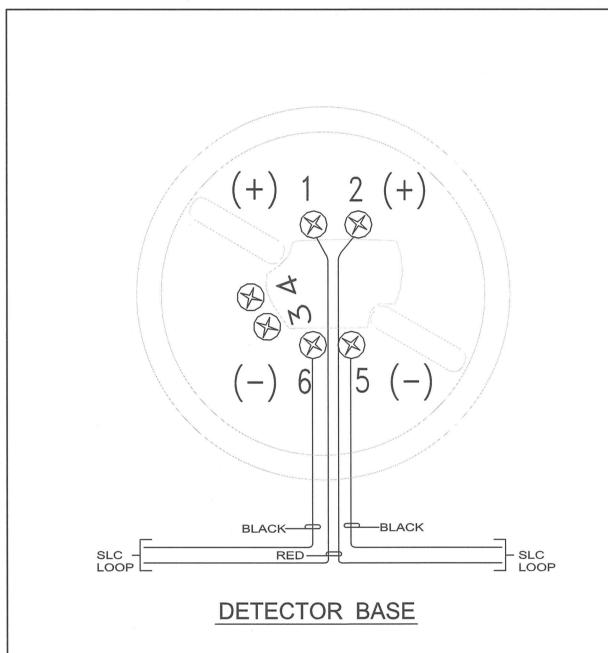

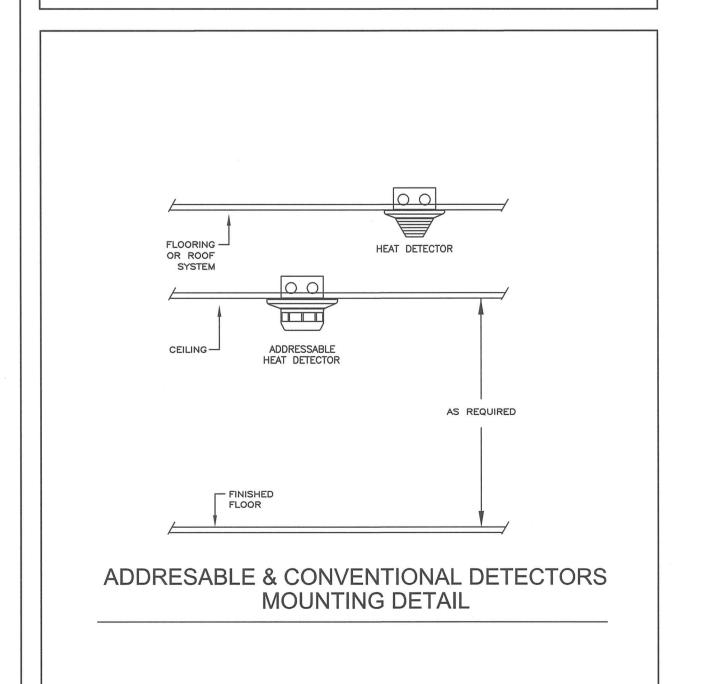



394-A Umbarger Rd San Jose, CA 95111 Phone 408.224.9890 Fax 408.224.9891 www.ArtikA3.com


Consultant Seal



Legend



Key Plan

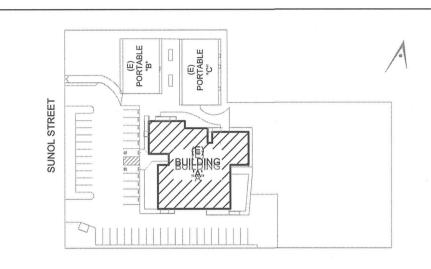

Project Title

# SUNOL COMMUNITY SCHOOL

258 SUNOL STREET

SAN JOSE, CA 95126

RESTROOMS UPGRADE

SANTA CLARA COUNTY OFFICE OF EDUCATION

No	Revisions/Submissions	Date
1	DSA SUBMITTAL	06/28/2017
2	DSA BACKCHECK SUBMITTAL	09/28/2017
	8	

FIRE ALARM DETAILS

Regulatory Agency Approval

Drawing Title





Architect Seal

File Number Drawing No

Project No. 06307

06/27/2017

Application Number

FA4.